DET

DETAIL

DIMENSION

PENSACOLA STATE COLLEGE-

MAIN CAMPUS SIGN

1000 COLLEGE BOULEVARD PENSACOLA, FLORIDA 32504

APRIL 30, 2012

INV EL

INVERT ELEVATION


DESIGN TEAM


| ARCHITECT: BULLOCK TICE ASSOCIATES 909 EAST CERVANTES STREET PENSACOLA, FL 32501 LARRY W. ADAMS, JR., AIA PHONE: (850) 434-5444 | ELECTRICAL: KLOCKE AND ASSOCIATES 49 EAST CHASE STREET PENSACOLA, FL 32501 JACK KLOCKE, P.E. PHONE: (850) 434-0989 |
|---|--|
| STRUCTURAL: JOE DEREUIL ASSOCIATES, LLC 301 WEST CERVANTES STREET PENSACOLA, FL 32501 BRAD BOWMAN, P.E. PHONE: (850) 429-1951 | |
| | |
| | |

| ABBREVIATIONS | | | | | | | |
|---------------|----------------------------|---------|----------------------------|-------|---------------------------|-------------|---------------------------------|
| & | AND | DIV | DIVISION | INSUL | INSULATE(D), (ING), (ION) | REBARS | REINFORCING BARS |
| @ | AT | DS | DOWNSPOUT | INT | INTERIOR | RCP | REFLECTED CEILING PLAN |
| Ĺ | ANGLE | DL | DRAIN LEADER | INV | INVERT | RET | RETURN |
| CL | CENTERLINE, CLASS, CLOSE | DWG | DRAWING | JT | JOINT | RA | RETURN AIR |
| CL C | CHANNEL | DF | DRINKING FOUNTAIN | KIT | KITCHEN | REV | REVISION(S), REVISED |
| AFF | ABOVE FINISH FLOOR | DW | DISHWASHER | LAM | LAMINATE(D) | RH | RIGHT HAND |
| ACT | ACOUSTICAL TILE | EF | EACH FACE | LAV | LAVATORY | ROW | RIGHT OF WAY |
| ADJ | ADJACENT | Е | EAST | L | LENGTH | RD | ROOF DRAIN |
| A/C | AIR CONDITIONING | ELEC | ELECTRIC(AL) | LH | LEFT HAND | RFG | ROOFING |
| ALT | ALTERNATE | EWC | ELECTRIC WATER COOLER | LP | LAMPPOLE | RM | ROOM |
| ALUM | ALUMINUM | EL | ELEVATION | MH | MANHOLE | SCHED | SCHEDULE |
| ARCH | ARCHITECT(URAL) | ELEV | ELEVATOR | MFR | MANUFACTURER | SECT | SECTION |
| AUTO | AUTOMATIC` ´ | EQ | EQUAL | MAX | MAXIMUM | SF | SQUARE FOOT/FEET |
| BRG | BEARING | EQUIP | EQUIPMENT | MECH | MECHANIC(AL) | SS | SERVICE SINK |
| BRG PL | BEARING PLATE | EXH | EXHAUST | MTL | METAL `´ | SHT | SHEET |
| BM | BEAM, BENCH MARK | EXIST | EXISTING | M | METER(S) | SIM | SIMILAR |
| BLKG | BLOCKING | EXT | EXTERIOR | MM | MILLIMÈTER(S) | SC S | SOLID CORE SOUTH |
| BD | BOARD | FFE | FINISHED FLOOR ELEVATION | MIN | MINIMUM | S SPKR | SPEAKER |
| BOT | BOTTOM | FA | FIRE ALARM | MISC | MISCELLANEOUS | SPEC | SPECIFICATION(S) |
| BLDG | BUILDING | FIN GR | FINISH GRADE | MT | MOUNT | SQ | SQUARE |
| BUR | BUILT-UP ROOFING | FE | FIRE EXTINGUISHER | MTD | MOUNTED | STD | STANDARD |
| CAB | CABINET | FEB | FIRE EXTINGUISHER BRACKET | MTG | MOUNTING | STA | STATION |
| CPT | CARPET(ED) | FEC | FIRE EXTINGUISHER CABINET | MULL | MULLION | STL | STEEL |
| CI | CAST IRON | FP | FIREPROOF | NAT | NATURAL | STOR | STORAGE |
| CB | CATCH BASIN | FLR | FLOOR | NOM | NOMINAL | SD | STORM DRAIN |
| CF/CI | CONTRACTOR FURNISHED | FD | FLOOR DRAIN | N | NORTH | STRUCT | STRUCTURAL |
| | CONTRACTOR INSTALLED | FTG | FOOTING | NIC | NOT IN CONTRACT | SUSP | SUSPENDED |
| CF/GI | CONTRACTOR FURNISHED/ | FDTN | FOUNDATION | NTS | NOT TO SCALE | SYMM | SYMMETRY(ICAL) |
| | GOVERNMENT INSTALLED | GA | GAGE | OC | ON CENTER(S) | SYS | SYSTEM |
| CK | CAULK(ING) | GALV | GALVANIZED IRON | OF/OI | OWNER FURNISH/ | TE | TOP ELEVATION |
| CLG | CEILING | GC | GENERAL CONTRACT(OR) | | OWNER INSTALLED | TEL | TELEPHONE |
| CEM | CEMENT | GEJ | GUTTER EXPANSION JOINT | OF/CI | OWNER FURNISH/ | TOC | TOP OF CONCRETE |
| CID | COMPREHENSIVE INTERIOR | GL | GLASS, GLAZING | | CONTRACTOR INSTALLED | TOP | TOP OF PAVING |
| | DESIGN PACKAGE | GB | GRAB BAR | OPNG | OPENING | TV | TELEVISION |
| CM | CENTIMETER(S) | GR LN | GRADE LINE | OPP | OPPOSITE | THK | THICK(NESS) |
| CLR | CLEAR(ANCE) | GF/GI | GOVERNMENT FURNISHED/ | OD | OUTSIDE DIAMETER | T&B | TOP AND BOTTOM |
| COL | COLUMN | | GOVERNMENT INSTALLED | OH | OVERHEAD, OVERHANG | T&G | TONGUE AND GROOVE |
| CONC | CONCRETE | GF/CI | GOVERNMENT FURNISHED/ | PRKG | PARKING | TOS | TOP OF SLAB, TOP OF STEEL |
| COR | CONTRACTING OFFICER'S | | CONTRACTOR INSTALLED | PVMT | PAVEMENT | TYP | TYPICAL UNLESS NOTED OTHERWISE |
| | REPRESENTATIVE | GMS | GALVANIZED METAL STUD | PLAM | PLASTIC LAMINATE | UNO VERT | VERTICAL |
| CMU | CONCRETE MASONRY UNIT | GYP BD | GYPSUM BOARD | PL | PROPERTY LINE | VERT | VERTICAL VINYL COMPOSITION TILE |
| COND | CONDITION | HDBD | HARDBOARD | PLYWD | PLYWOOD | WSCT | WAINSCOT |
| CONSTR | CONSTRUCTION | HDW | HARDWARE | PVC | POLYVINYL CHLORIDE | WC | WATER CLOSET |
| CONT | CONTINUOUS OR CONTINUE | HTG | HEATING | PCF | POUNDS PER CUBIC FOOT | WH | WATER CLOSET WATER HEATER |
| CONTR | CONTRACT(OR) | HVAC | HEATING/VENTILATING/AIR | PSF | POUNDS PER SQUARE FOOT | WP | WATERPROOFING |
| CJ | CONSTRUCTION/CONTROL JOINT | HT | HEIGHT | PSI | POUNDS PER SQUARE INCH | WWF | WELDED WIRE FABRIC |
| CORR | CORRIDOR | HC | HOLLOW CORE, HANDICAP(PED) | PCC | PRECAST CONCRETE | W | WEST, WIDTH, WIDE |
| COTR | CONTRACTING OFFICER | HM | HOLLOW METAL | PL | PLATE | W/ | WITH |
| 011.57 | TECHNICAL REP | HORIZ | HORIZONTAL | PT | PRESSURE TREATED | W/O | WITHOUT |
| CU FT | CUBIC FOOT | HB | HOSE BIBB | QT | QUARRY TILE | WD | WOOD |
| CU YD | CUBIC YARD | HS | HOT STACK | R | RADIUS, RISER, RANGE | WB | WOOD BASE |
| CW | CURTAIN WALL | INCL | INCLUDE(D), (ING) | REF | REFERENCE, REFRIGERATOR | | |
| DIA | DIAMETER | ID | INSIDE DIAMETER | REG | REGISTER | | |
| 1 1 L I | 1.16 1.7 H | INIV L1 | | | | | |


REINF

REINFORCE(D), (ING)

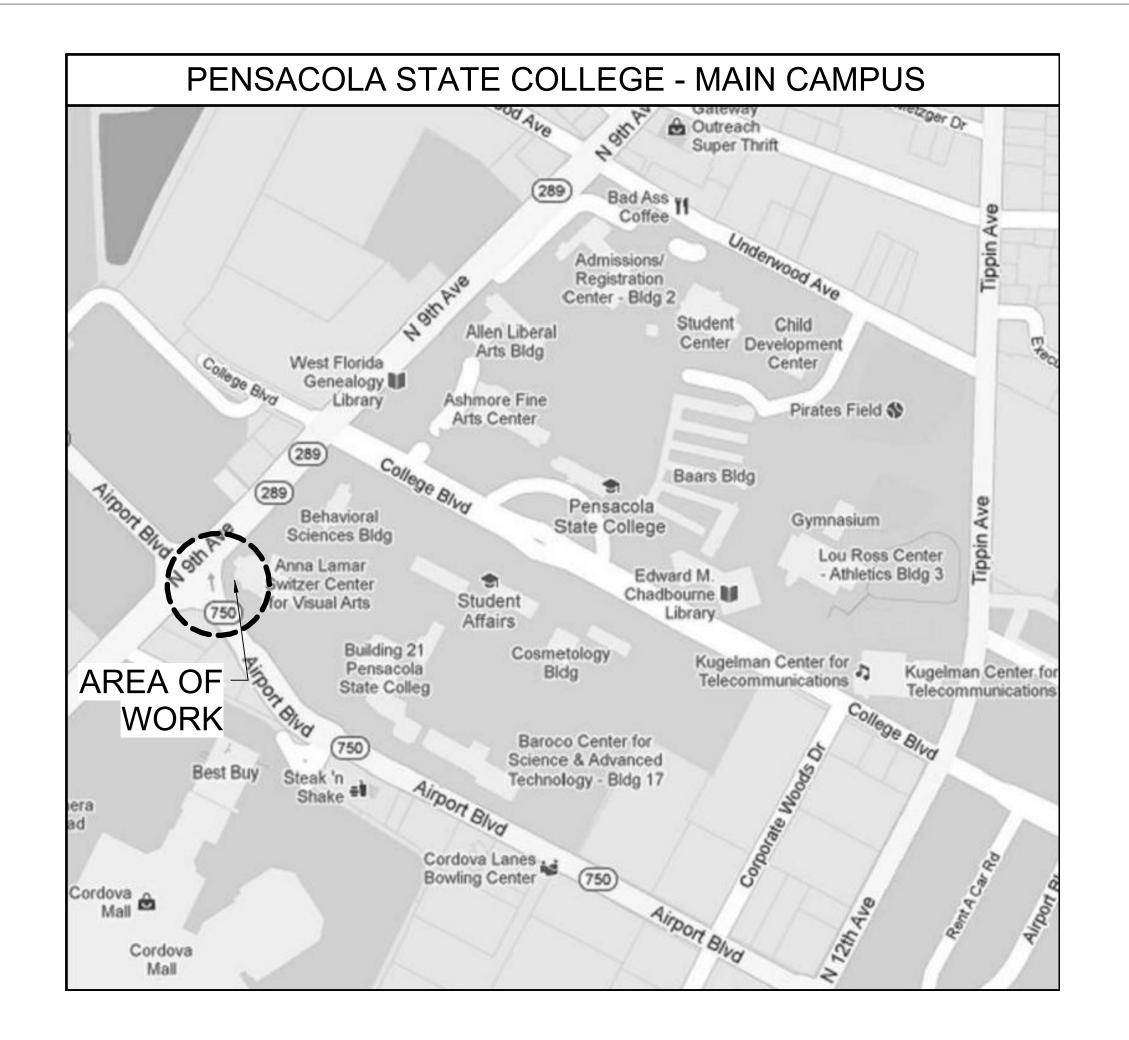

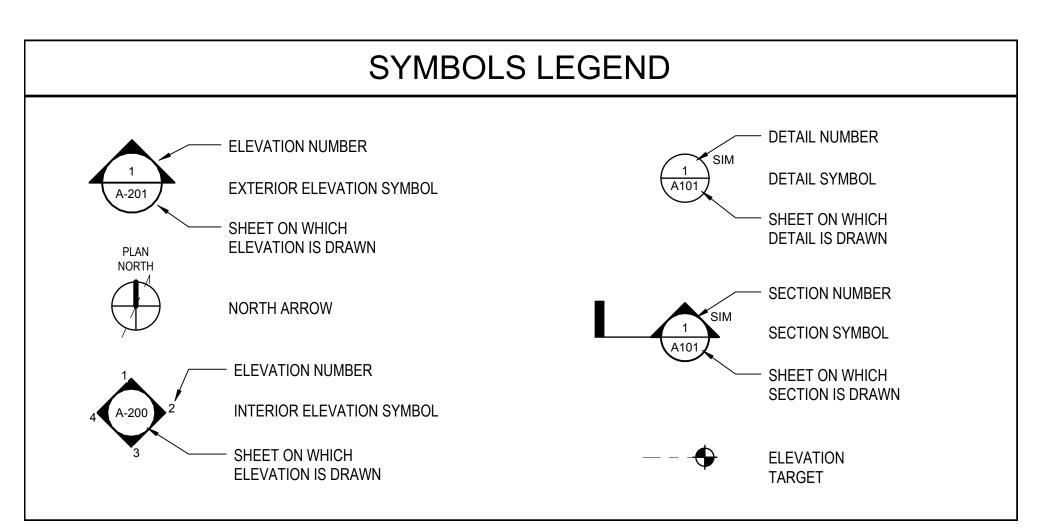

| INDEX OF DRAWINGS | | | | | |
|-------------------|--|-------------|--|--|--|
| SHEET NUMBER | SHEET NAME | SHEET ISSUE | | | |
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| STRUCTURAL | | | | | |
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| S-201 | SECTIONS | 04/02/12 | | | |
| ARCHITECTURAL | | | | | |
| A-101 | SIGNAGE PLAN, ELEVATION AND DETAILS | 04/30/12 | | | |
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| ELECTRICAL | | | | | |
| E001 | ELECTRICAL SITE PLAN | 04/03/12 | | | |
| E101 | ELECTRICAL DEMOLITION AND NEW WORK PLANS | 04/03/12 | | | |

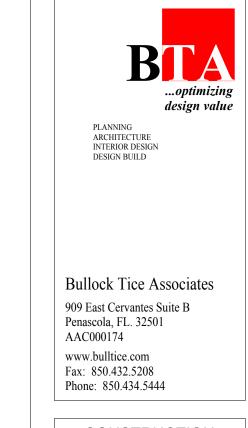

CONSTRUCTION **DOCUMENTS** APRIL 30, 2012


SIGNATURE AND SEAL LARRY W. ADAMS, JR., AIA FLORIDA LICENSE NO. AR91583

ENS/

BTA PROJECT NO: 131711.05 SHEET DATE:

COVER SHEET

G-001

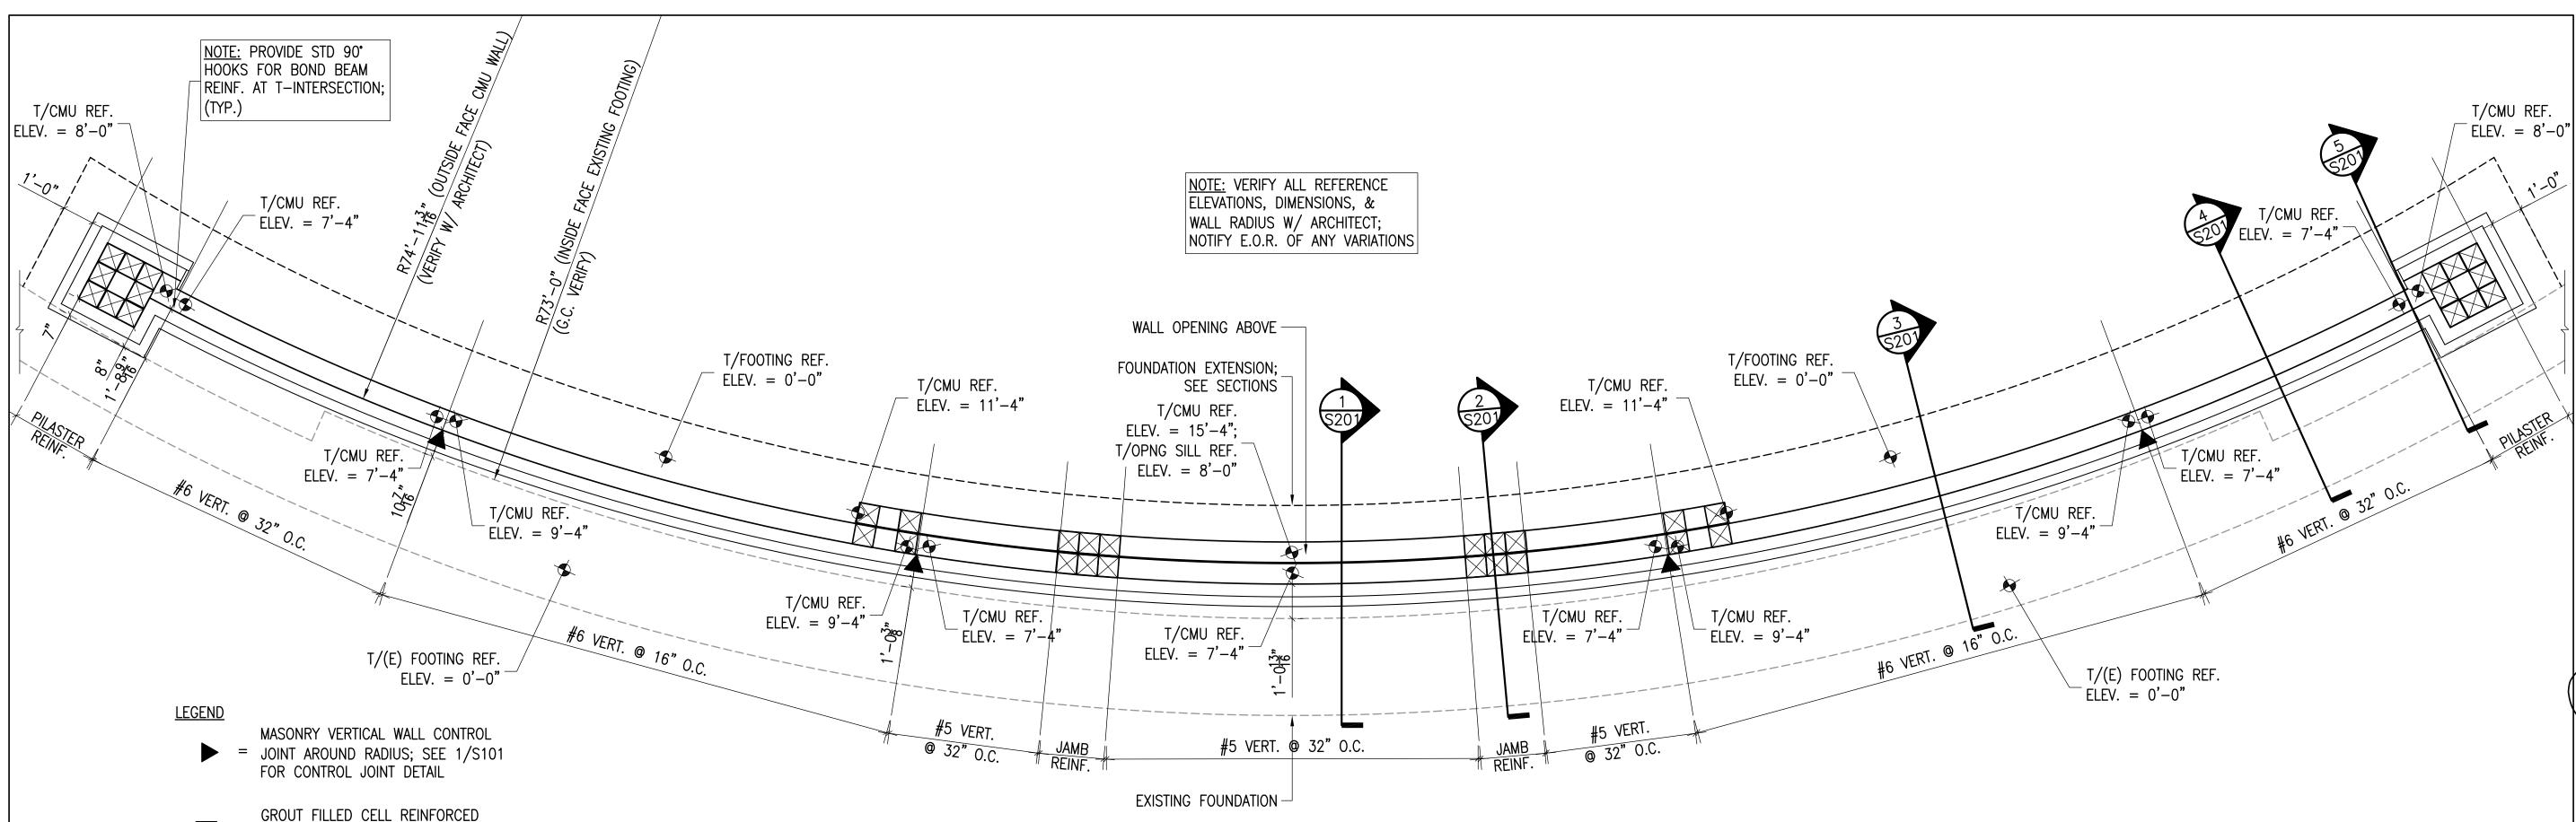

1.00 GENERAL NOTES

1.01 THE STRUCTURE HAS BEEN DESIGNED UTILIZING THE FOLLOWING REFERENCES:

IN CELL

A. FLORIDA BUILDING CODE, LATEST EDITION

B. ASCE 7-10. MINIMUM DESIGN LOADS FOR BUILDINGS AND OTHER STRUCTURES

= W/ (1) #5 VERTICAL CENTERED

- C. ACI 318-08, BUILDING CODE REQUIREMENTS FOR CONCRETE STRUCTURES
- D. <u>ACI 530-08, BUILDING CODE REQUIREMENTS FOR MASONRY STRUCTURES</u>

1.02 WIND LOADS - STRUCTURE HAS BEEN DESIGNED TO CONFORM TO THE WIND PROVISIONS OF ASCE 7-10.

- A. BASIC WIND SPEED: 140 MPH B. WIND RISK CATEGORY: I
- C. WIND EXPOSURE CATEGORY: C
- D. COMPONENT & CLADDING WIND PRESSURE (WALL): 55 PSF (ALLOWABLE)
- 1.03 COORDINATE STRUCTURAL CONTRACT DOCUMENTS WITH ARCHITECTURAL AND ELECTRICAL. NOTIFY STRUCTURAL ENGINEER OF ANY CONFLICT AND/OR OMISSION. CONTRACTOR SHALL MAKE NO DEVIATION FROM DESIGN DRAWINGS WITHOUT WRITTEN APPROVAL OF THE ARCHITECT.

2.00 FOUNDATIONS

- 2.01 AT THIS TIME NO GEOTECHNICAL REPORT HAS BEEN SUBMITTED. AN ALLOWABLE SOIL BEARING PRESSURE OF 1500 PSF HAS BEEN CONSERVATIVELY ESTIMATED BASED ON SIMILAR PROJECTS OF THIS SIZE AND LOCATED IN THE SAME GENERAL AREA OF CONSTRUCTION. A QUALIFIED GEOTECHNICAL ENGINEER SHALL CHECK COMPACTION OF THE FOOTINGS. THE SOILS IMMEDIATELY BENEATH ALL FOOTINGS SHOULD BE COMPACTED FOR A MINIMUM DEPTH OF 12 INCHES TO A MINIMUM OF 95% OF THE SOIL'S MAXIMUM DENSITY AS DETERMINED BY THE MODIFIED PROCTOR TEST (ASTM D1557) USING A LARGE TAMPER.
- 2.02 SIDES OF FOUNDATIONS SHALL BE FORMED UNLESS CONDITIONS PERMIT EARTH FORMING. FOUNDATIONS POURED AGAINST THE EARTH REQUIRE THE FOLLOWING PRECAUTIONS: SLOPE SIDES OF EXCAVATIONS AS APPROVED BY GEOTECHNICAL ENGINEER AND CLEAN UP SLOUGHING BEFORE AND DURING CONCRETE PLACEMENT.

3.00 REINFORCED CONCRETE

- 3.01 ALL CONCRETE WORK SHALL CONFORM TO ACI 301-10, SPECIFICATIONS FOR STRUCTURAL CONCRETE FOR BUILDINGS. DESIGN IS BASED ON ACI 318-08, BUILDING CODE REQUIREMENTS FOR REINFORCED CONCRETE. DETAIL CONCRETE REINFORCEMENT AND ACCESSORIES IN ACCORDANCE WITH ACI 315, DETAILING MANUAL. DETAIL ALL CONCRETE WALLS AND BEAMS ON THE SHOP DRAWINGS IN ELEVATION UNLESS SPECIFICALLY APPROVED OTHERWISE. SUBMIT SHOP DRAWINGS FOR APPROVAL, SHOWING ALL FABRICATION DIMENSIONS AND LOCATIONS FOR PLACING REINFORCING STEEL AND ACCESSORIES. DO NOT BEGIN FABRICATION UNTIL SHOP DRAWINGS ARE COMPLETED AND REVIEWED.
- 3.02 UNLESS NOTED OTHERWISE, ALL CONCRETE SHALL BE NORMAL WEIGHT AND HAVE THE FOLLOWING MINIMUM 28 DAY COMPRESSIVE STRENGTHS:
- A. FOUNDATIONS 3000 PSI B. BEAMS *4000 PSI

*MAXIMUM W/CM RATIO 0.40, 20-25% FLYASH AND 4-6% AIR CONTENT

CONCRETE MAY CONTAIN A PROPERLY DESIGNED SUPERPLASTICIZER FOR WORKABILITY.

- 3.03 REINFORCING STEEL SHALL CONFORM TO ASTM A615, GRADE 60 UNLESS NOTED OTHERWISE. RIENFORCING SHALL BE CONTINUOUS AND LAP A MINIMUM OF 48 BAR DIAMETERS UNLESS NOTED OTHERWISE.
- 3.04 THE PROPOSED MATERIALS AND MIX DESIGN SHALL BE FULLY DOCUMENTED AND REVIEWED BY THE CONTRACTOR'S TESTING LABORATORY. RESPONSIBILITY FOR OBTAINING THE REQUIRED DESIGN STRENGTH IS THE CONTRACTOR'S.


FOUNDATION PLAN

3/8" = 1'-0"

- 3.05 TIE ALL REINFORCING STEEL AND EMBEDMENTS SECURELY IN PLACE PRIOR TO PLACING CONCRETE. PROVIDE SUFFICIENT SUPPORTS TO MAINTAIN THE POSITION OF REINFORCEMENT WITHIN SPECIFIED TOLERANCE DURING ALL CONSTRUCTION ACTIVITIES. "STICKING" DOWELS INTO WET CONCRETE IS NOT PERMITTED.
- 3.06 ALL REINFORCING STEEL PLACEMENTS SHALL BE REVIEWED BY A REGISTERED STRUCTURAL ENGINEER, OR BY A REPRESENTATIVE RESPONSIBLE TO HIM. (RE: ACI 318 PAR. 1.3.1)

4.00 MASONRY


- 4.01 CONCRETE MASONRY DESIGN AND CONSTRUCTION SHALL CONFORM TO ACI 530, BUILDING CODE REQUIREMENTS FOR CONCRETE MASONRY STRUCTURES AND ACI 530.1, SPECIFICATIONS FOR CONCRETE MASONRY CONSTRUCTION.
- 4.02 PROVIDE LIGHTWEIGHT, HOLLOW, LOAD-BEARING CONCRETE MASONRY UNITS (CMU) CONFORMING TO ASTM C90, fc' = 1900 PSI (NET). UNLESS NOTED OTHERWISE.
- 4.03 PROVIDE MASONRY CONSTRUCTION WITH MINIMUM COMPRESSIVE STRENGTH, f'm = 1500 PSI.
- 4.04 PROVIDE TYPE "S" OR TYPE "M" MORTAR FOR ALL CONCRETE MASONRY IN ACCORDANCE WITH ASTM C270. UNLESS NOTED OTHERWISE.
- 4.05 VERTICAL REINFORCING SHALL BE CONTINUOUS (LAPPED 48 BAR DIAMETERS AT SPLICES) AND HELD IN POSITION AT THE TOP AND BOTTOM OF THE GROUT POUR WITH BAR POSITIONERS. UNO, POSITION VERTICAL REINFORCING IN THE CENTER OF THE CELL.
- 4.06 PROVIDE GROUT FOR REINFORCED MASONRY IN ACCORDANCE WITH ASTM C476. GROUT SHALL HAVE A MINIMUM 28 DAY COMPRESSIVE STRENGTH OF 3,000 PSI UNLESS NOTED OTHERWISE. GROUT SHALL BE FLUID CONSISTENCY. FLUID CONSISTENCY SHALL MEAN THAT CONSISTENCY AS FLUID AS POSSIBLE FOR POURING WITHOUT SEGREGATION OF THE CONSTITUENT PARTS. ALL GROUT SHALL BE CONSOLIDATED AT THE TIME OF POURING BY VIBRATING AND THEN RECONSOLIDATED BY AGAIN PUDDLING LATER. BEFORE PLASTICITY IS LOST. WHEN GROUTING IS STOPPED FOR ONE HOUR OR LONGER. CONSTRUCTION JOINTS SHALL BE FORMED BY STOPPING THE POUR OF THE GROUT 1-1/2 INCHES BELOW THE TOP OF THE UPPERMOST UNIT.
- 4.07 PROVIDE HORIZONTAL JOINT REINFORCEMENT COMPLYING WITH ASTM A82, NO. 9 GAUGE OR HEAVIER, ZINC COATED, PLACED 16 INCHES ON CENTER UNLESS NOTED OTHERWISE.
- 4.08 PROVIDE RUNNING BONDS WITH VERTICAL JOINTS LOCATED AT CENTER OF MASONRY UNITS IN THE ALTERNATE COURSE BELOW, UNLESS NOTED OTHERWISE.
- 4.09 ALL MASONRY UNITS SHALL BE FREE OF EXCESSIVE DUST AND DIRT AT THE TIME THEY ARE LAYED BY THE MASON.

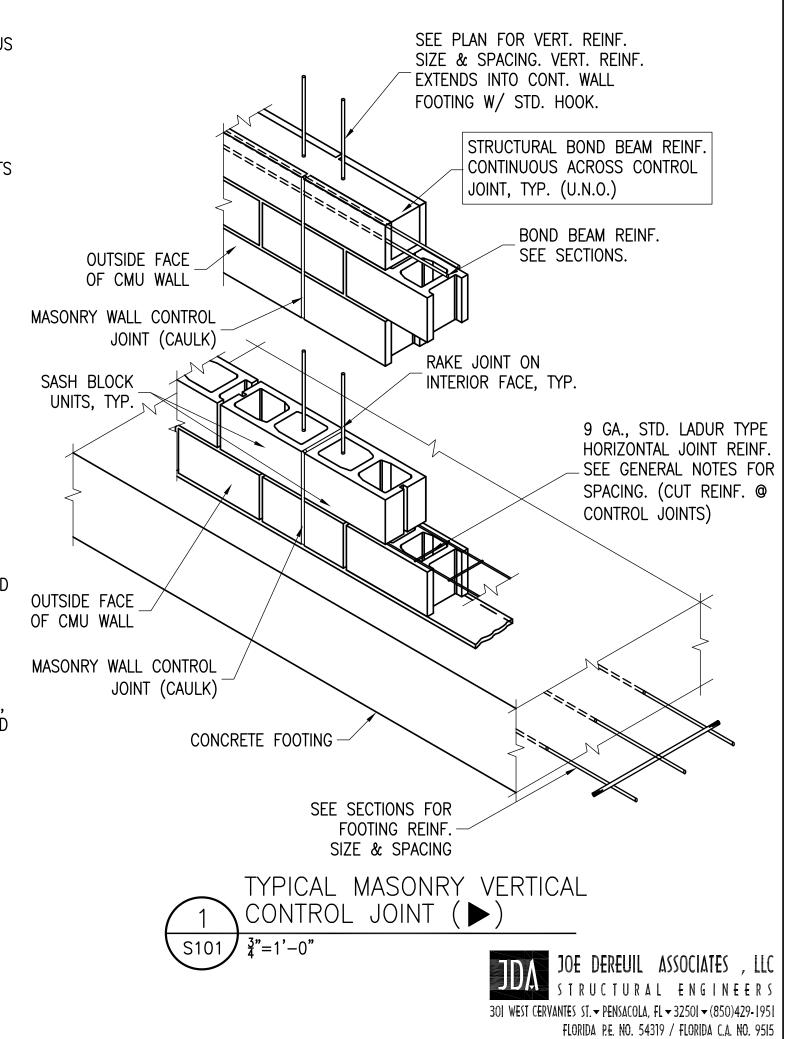

...optimizing design value **Bullock Tice Associates** 909 East Cervantes Suite B Penascola, FL. 32501 AAC000174 www.bulltice.com Fax: 850.432.5208 Phone: 850.434.5444

BTA

CONSTRUCTION **DOCUMENTS APRIL 2, 2012**

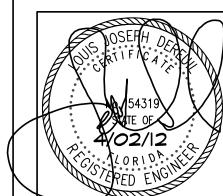


E COLLEGE -RENOVATION TATE IGN S ISACOLA (CAMPUS PEN:

REVISIONS BTA PROJECT NO: 131711.05

SHEET DATE: 4/2/12

GENERAL NOTES & FOUNDATION PLAN


S-101

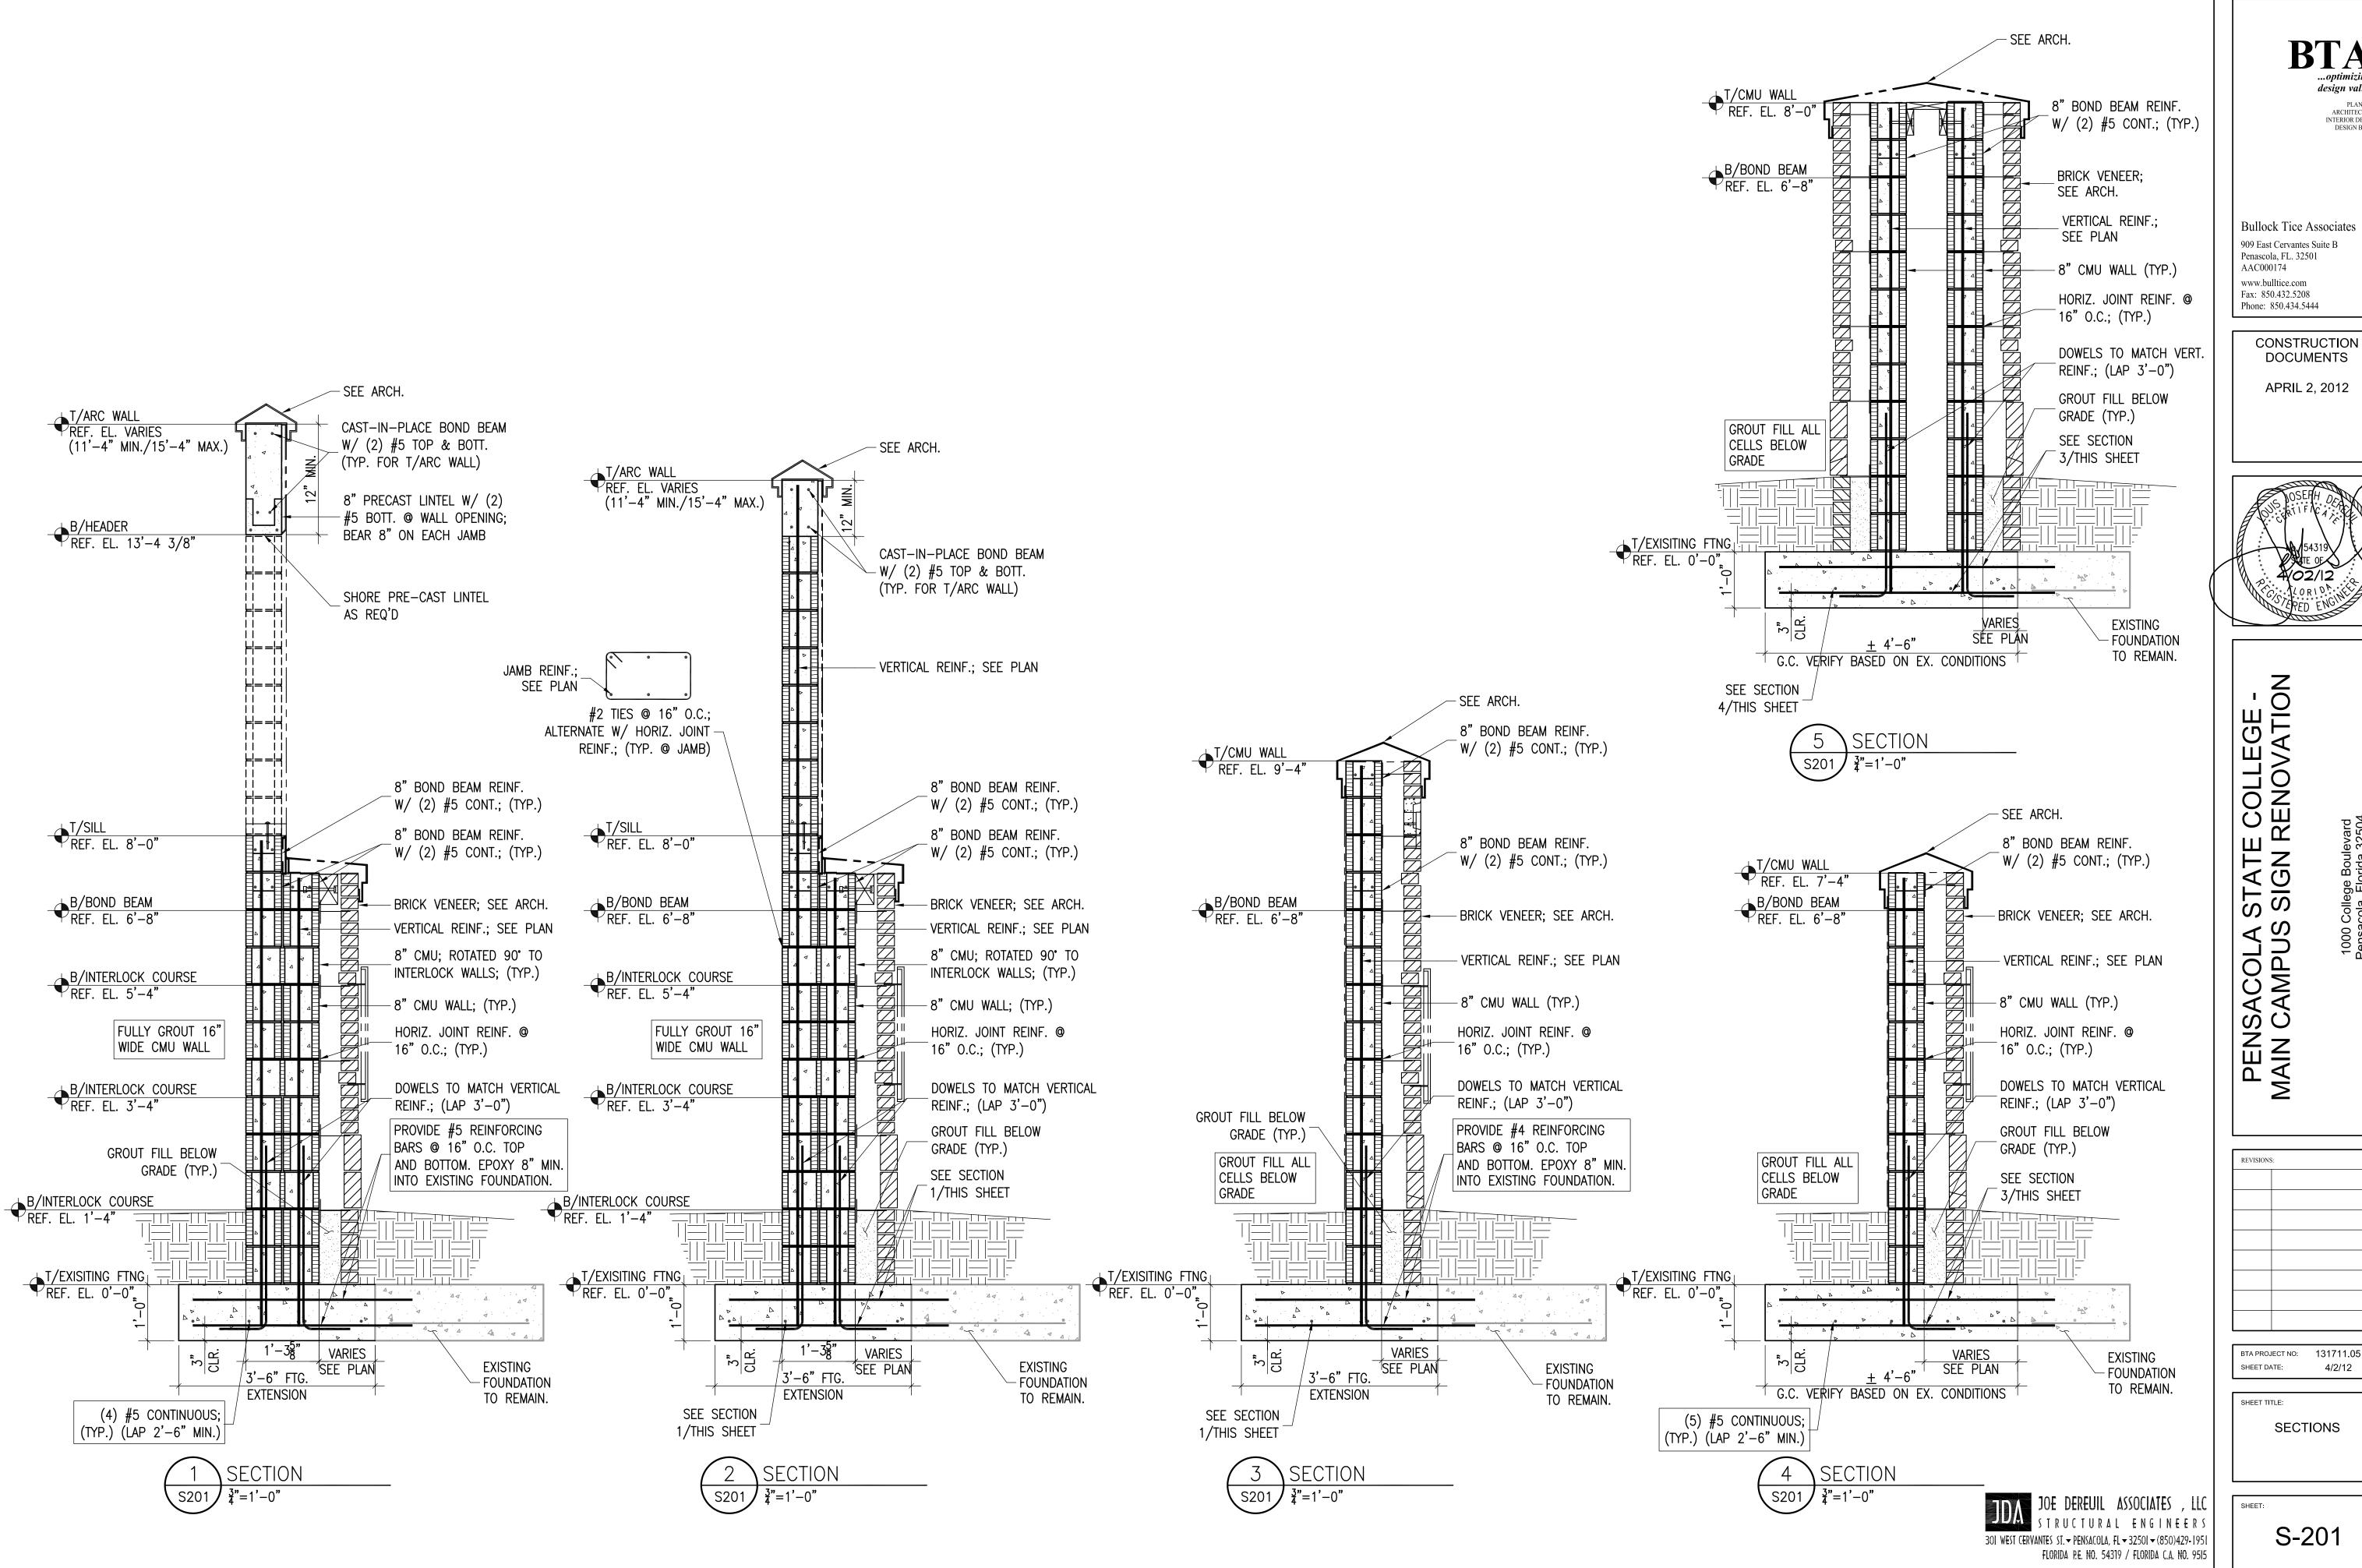


BTA ...optimizing design value PLANNING ARCHITECTURE INTERIOR DESIGN DESIGN BUILD

Bullock Tice Associates 909 East Cervantes Suite B

DOCUMENTS

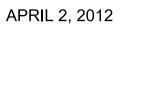

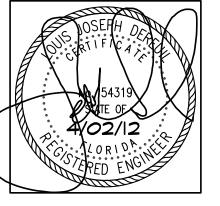

вта project no: 131711.05 4/2/12

SECTIONS

S-201




1. PLAN DRAWINGS ARE GENERATED BY A CUT THROUGH THE WALL AT A HEIGHT OF APPROXIMATELY 48". COMPONENTS IN OR ON THE WALL ABOVE OR BELOW THIS PLANE MAY NOT BE IDENTIFIED IN THIS PLAN VIEW. SEE ELEVATION VIEWS FOR IDENTIFICATION OF ALL WALL COMPONENTS AND OPENINGS.

2. REFER TO WALL SECTIONS FOR SPECIFIC DIMENSIONS FOR WALL CONSTRUCTION.

3. ALL DIMENSIONS SHOWN ON SIGNAGE PLAN ARE FROM FACE OF BRICK, EIFS, OR WHERE APPLICABLE.

ELEVATION GENERAL NOTES

- 2. PROVIDE CONTROL JOINTS AT EIFS BANDING AND EIFS WALL AS INDICATED ON ELEVATION.
- EXISTING ELECTRONIC SIGN TO CONFIRM ADEQUACY OF SIZE.

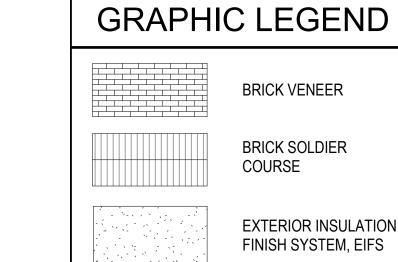

ELASTOMERIC

FINISH COAT

BACK WRAP


- 2 1/2" EIFS


8" CMU

GRAY VELOUR ACCENT (OCCURS AT RECESSED BANDS)



- REGULAR GRAY TYPE N

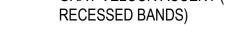

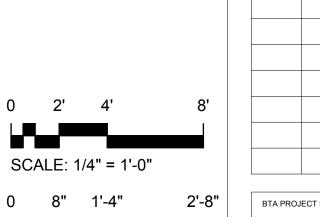

SCALE: 3/4" = 1'-0"

SCALE: 1 1/2" = 1'-0"

0 4" 8"


0 2" 4"

SCALE: 3" = 1'-0"

SHEET DATE:

SHEET TITLE: SIGNAGE PLAN, **ELEVATION AND DETAILS**

A-101

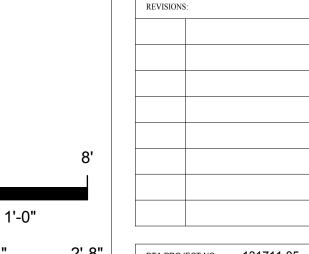

BTA PROJECT NO: 131711.05

COLLEGE

Bullock Tice Associates

CONSTRUCTION DOCUMENTS

APRIL 30, 2012

LARRY W. ADAMS, JR., AIA FLORIDA LICENSE NO. AR91583

909 East Cervantes Suite B Penascola, FL. 32501


AAC000174 www.bulltice.com Fax: 850.432.5208 Phone: 850.434.5444

SIGNATURE AND SEAL

PENSACOLA &

1. FOR EXTERIOR COLOR SCHEDULE, SEE COLOR SCHEDULE.

- 3. PROVIDE VERTICAL EXPANSION JOINTS AT ELEVATION CHANGES OF BRICK WALL AS INDICATED ON ELEVATION.
- 4. ELECTRONIC SIGN SUPPLIER SHALL VERIFY OPENING WITH

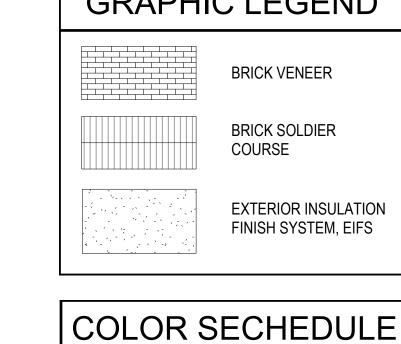

BRICK COLORS - B-1: CAROLINA CERAMICS CHERRY

- B-2: CAROLINA CERAMICS COLONIAL

MORTAR


PLAN DETAIL @ WALL JOIN
1 1/2" = 1'-0"

PLAN DETAIL @ PILASTER

3/4" = 1'-0"

PRE-CAST CONCRETE MEDALLION

3" = 1'-0"

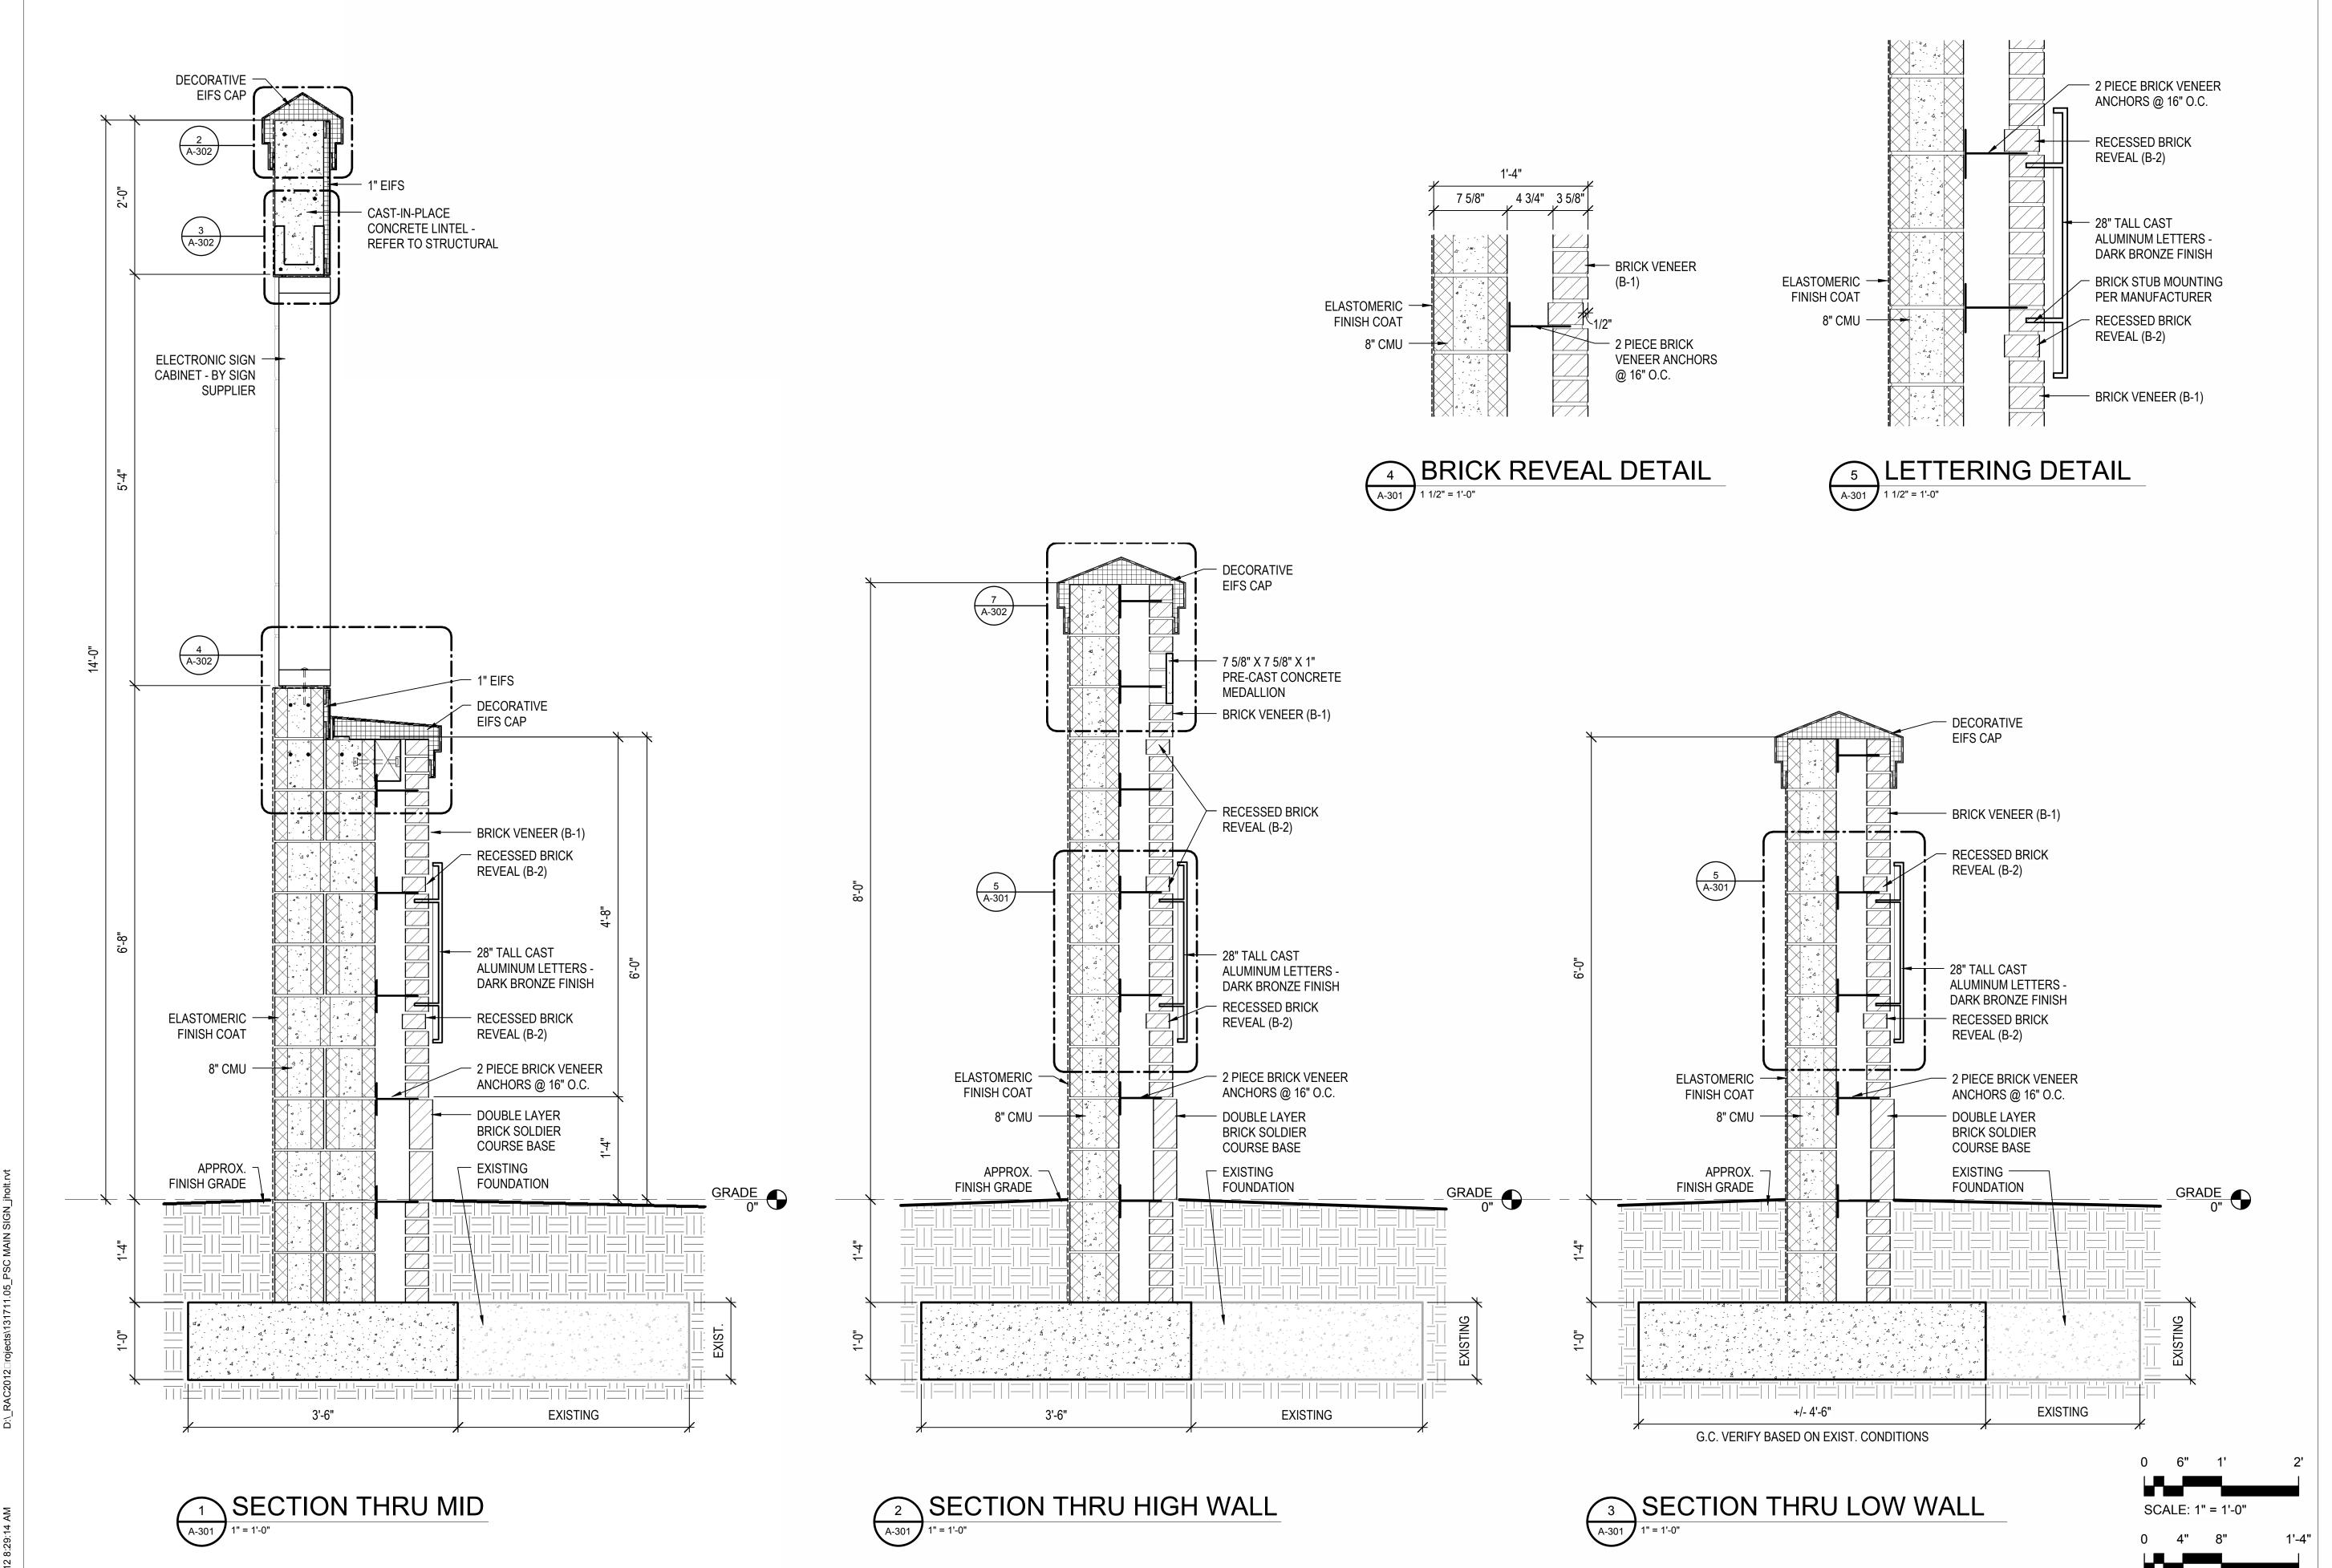

PLANNING ARCHITECTURE INTERIOR DESIGN DESIGN BUILD **Bullock Tice Associates** 909 East Cervantes Suite B Penascola, FL. 32501 AAC000174 www.bulltice.com

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Phone: 850.434.5444

CONSTRUCTION DOCUMENTS APRIL 30, 2012

SIGNATURE AND SEAL

LARRY W. ADAMS, JR., AIA FLORIDA LICENSE NO. AR91583

STATE COLLEGE AMPUS SIGN PENSACOLA S MAIN CA


REVISIONS:


BTA PROJECT NO: 131711.05 SHEET DATE: 04/30/12

SHEET TITLE: WALL SECTIONS

A-301


SCALE: 1 1/2" = 1'-0"

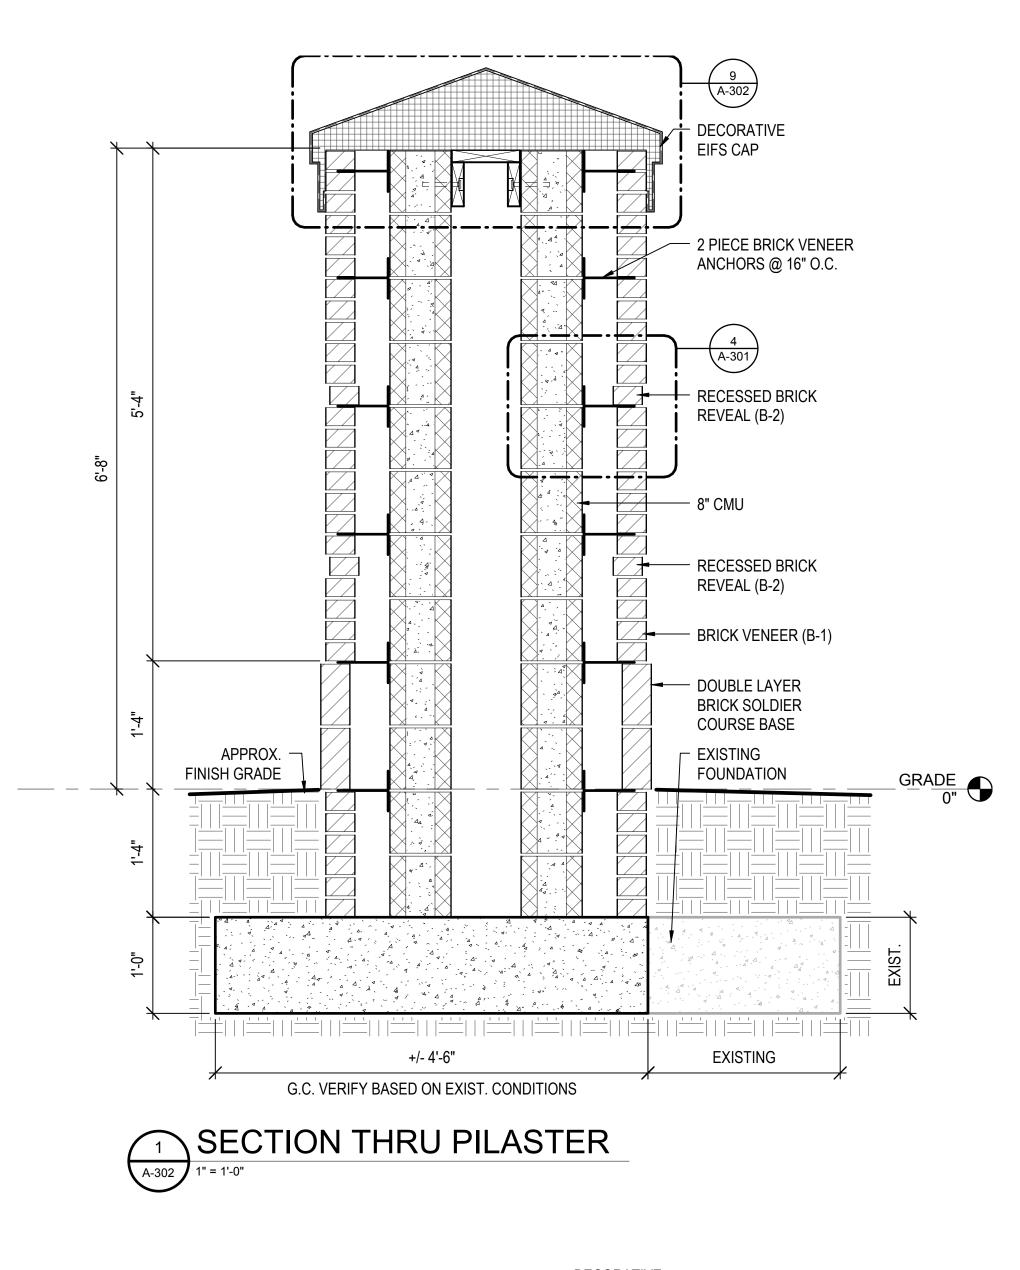

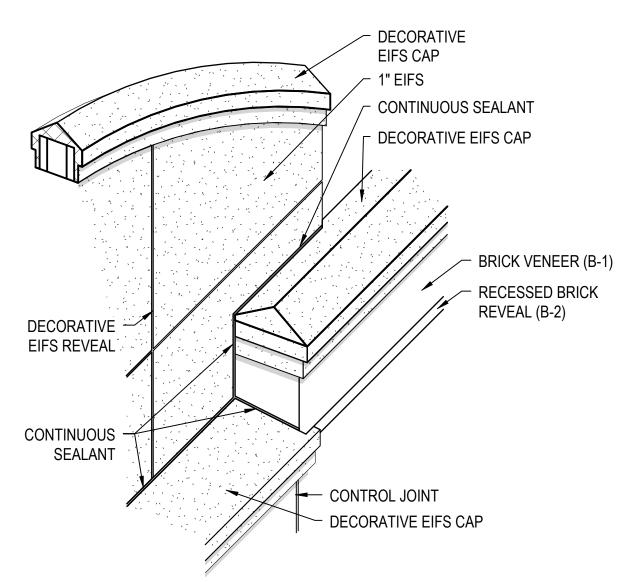


6 AXONOMETRIC DETAIL

1/2" = 1'-0"

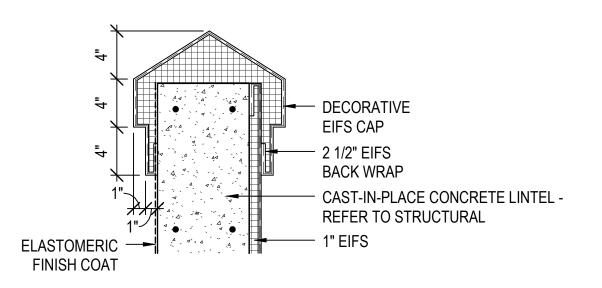


EIFS CAP DETAIL @ DIGITAL SIGNAGE WALL


1 1/2" = 1'-0"

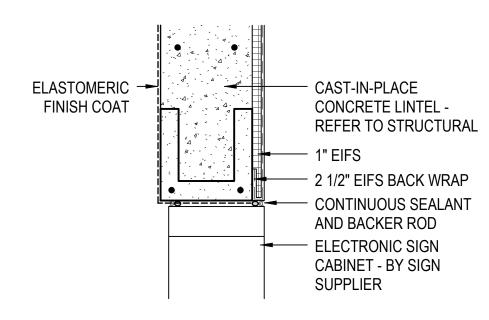


3 HEAD @ DIGITAL SIGN

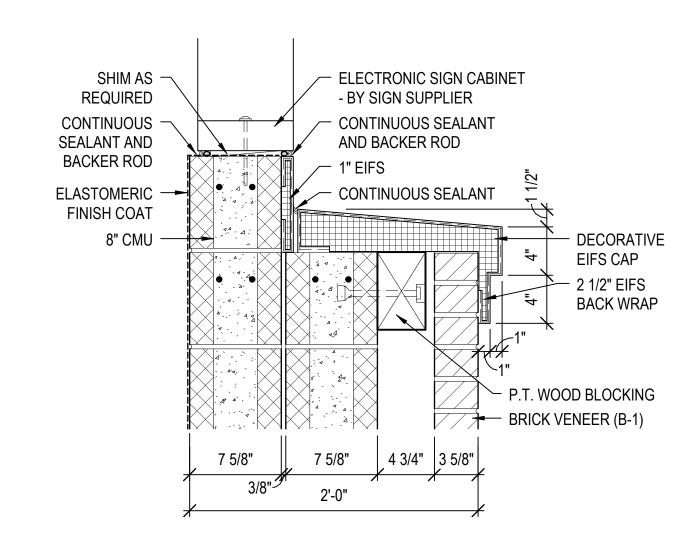


4 SILL @ DIGITAL SIGN
A-302 1 1/2" = 1'-0"

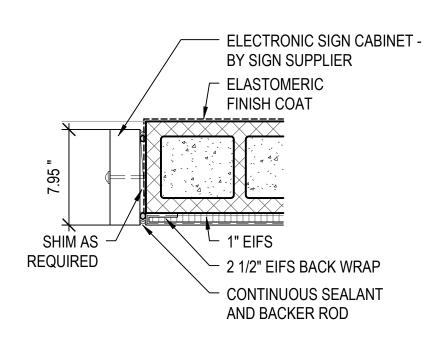


5 JAMB @ DIGITAL SIGN

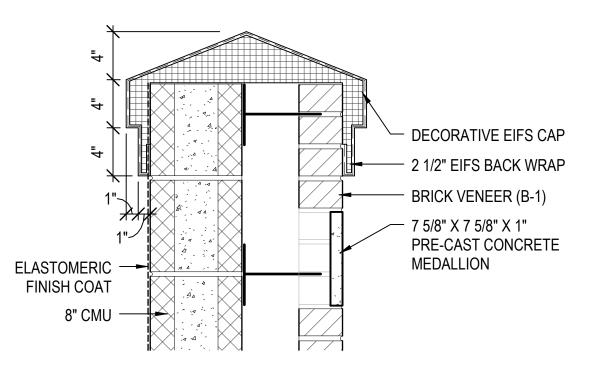


7 EIFS COPING DETAIL @ MEDALLION
1 1/2" = 1'-0"

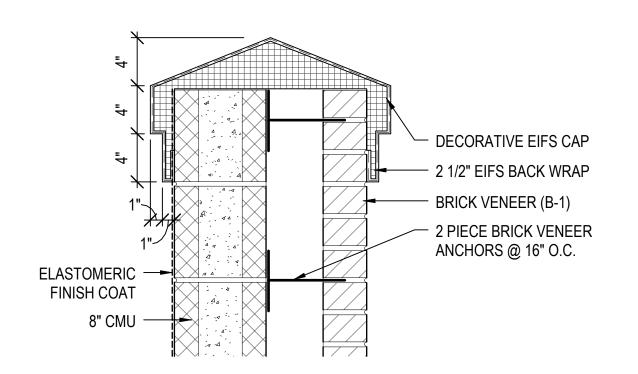

8 EIFS COPING DETAIL (TYP.)
1 1/2" = 1'-0"

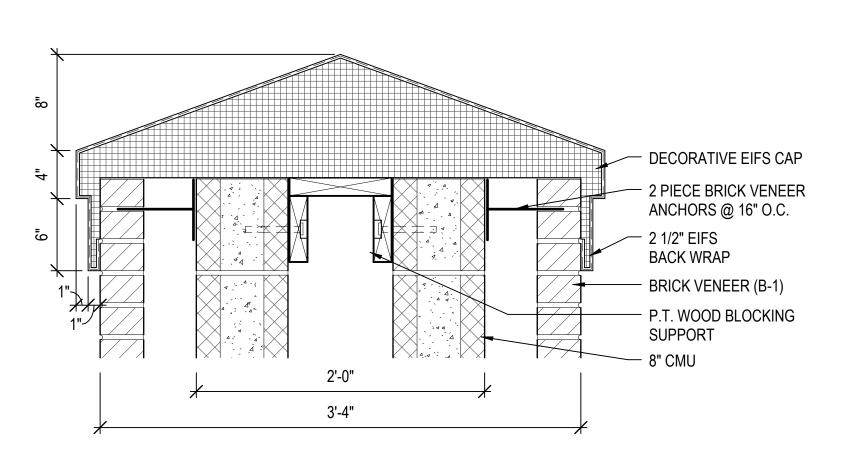

9 EIFS CAP DETAIL @ PILASTER
1 1/2" = 1'-0"

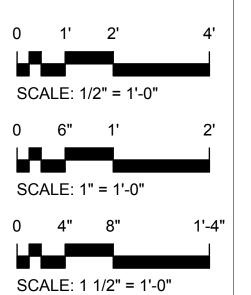

BILA
...optimizing
design value

PLANNING
ARCHITECTURE
INTERIOR DESIGN
DESIGN BUILD

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SIGNATURE AND SEAL

LARRY W. ADAMS, JR., AIA FLORIDA LICENSE NO. AR91583

PENSACOLA STATE COLLEGE MAIN CAMPUS SIGN


REVISIONS:

BTA PROJECT NO: 131711.05 SHEET DATE: 04/30/12

SHEET TITLE:

WALL SECTION AND DETAILS

1'-4" A-302

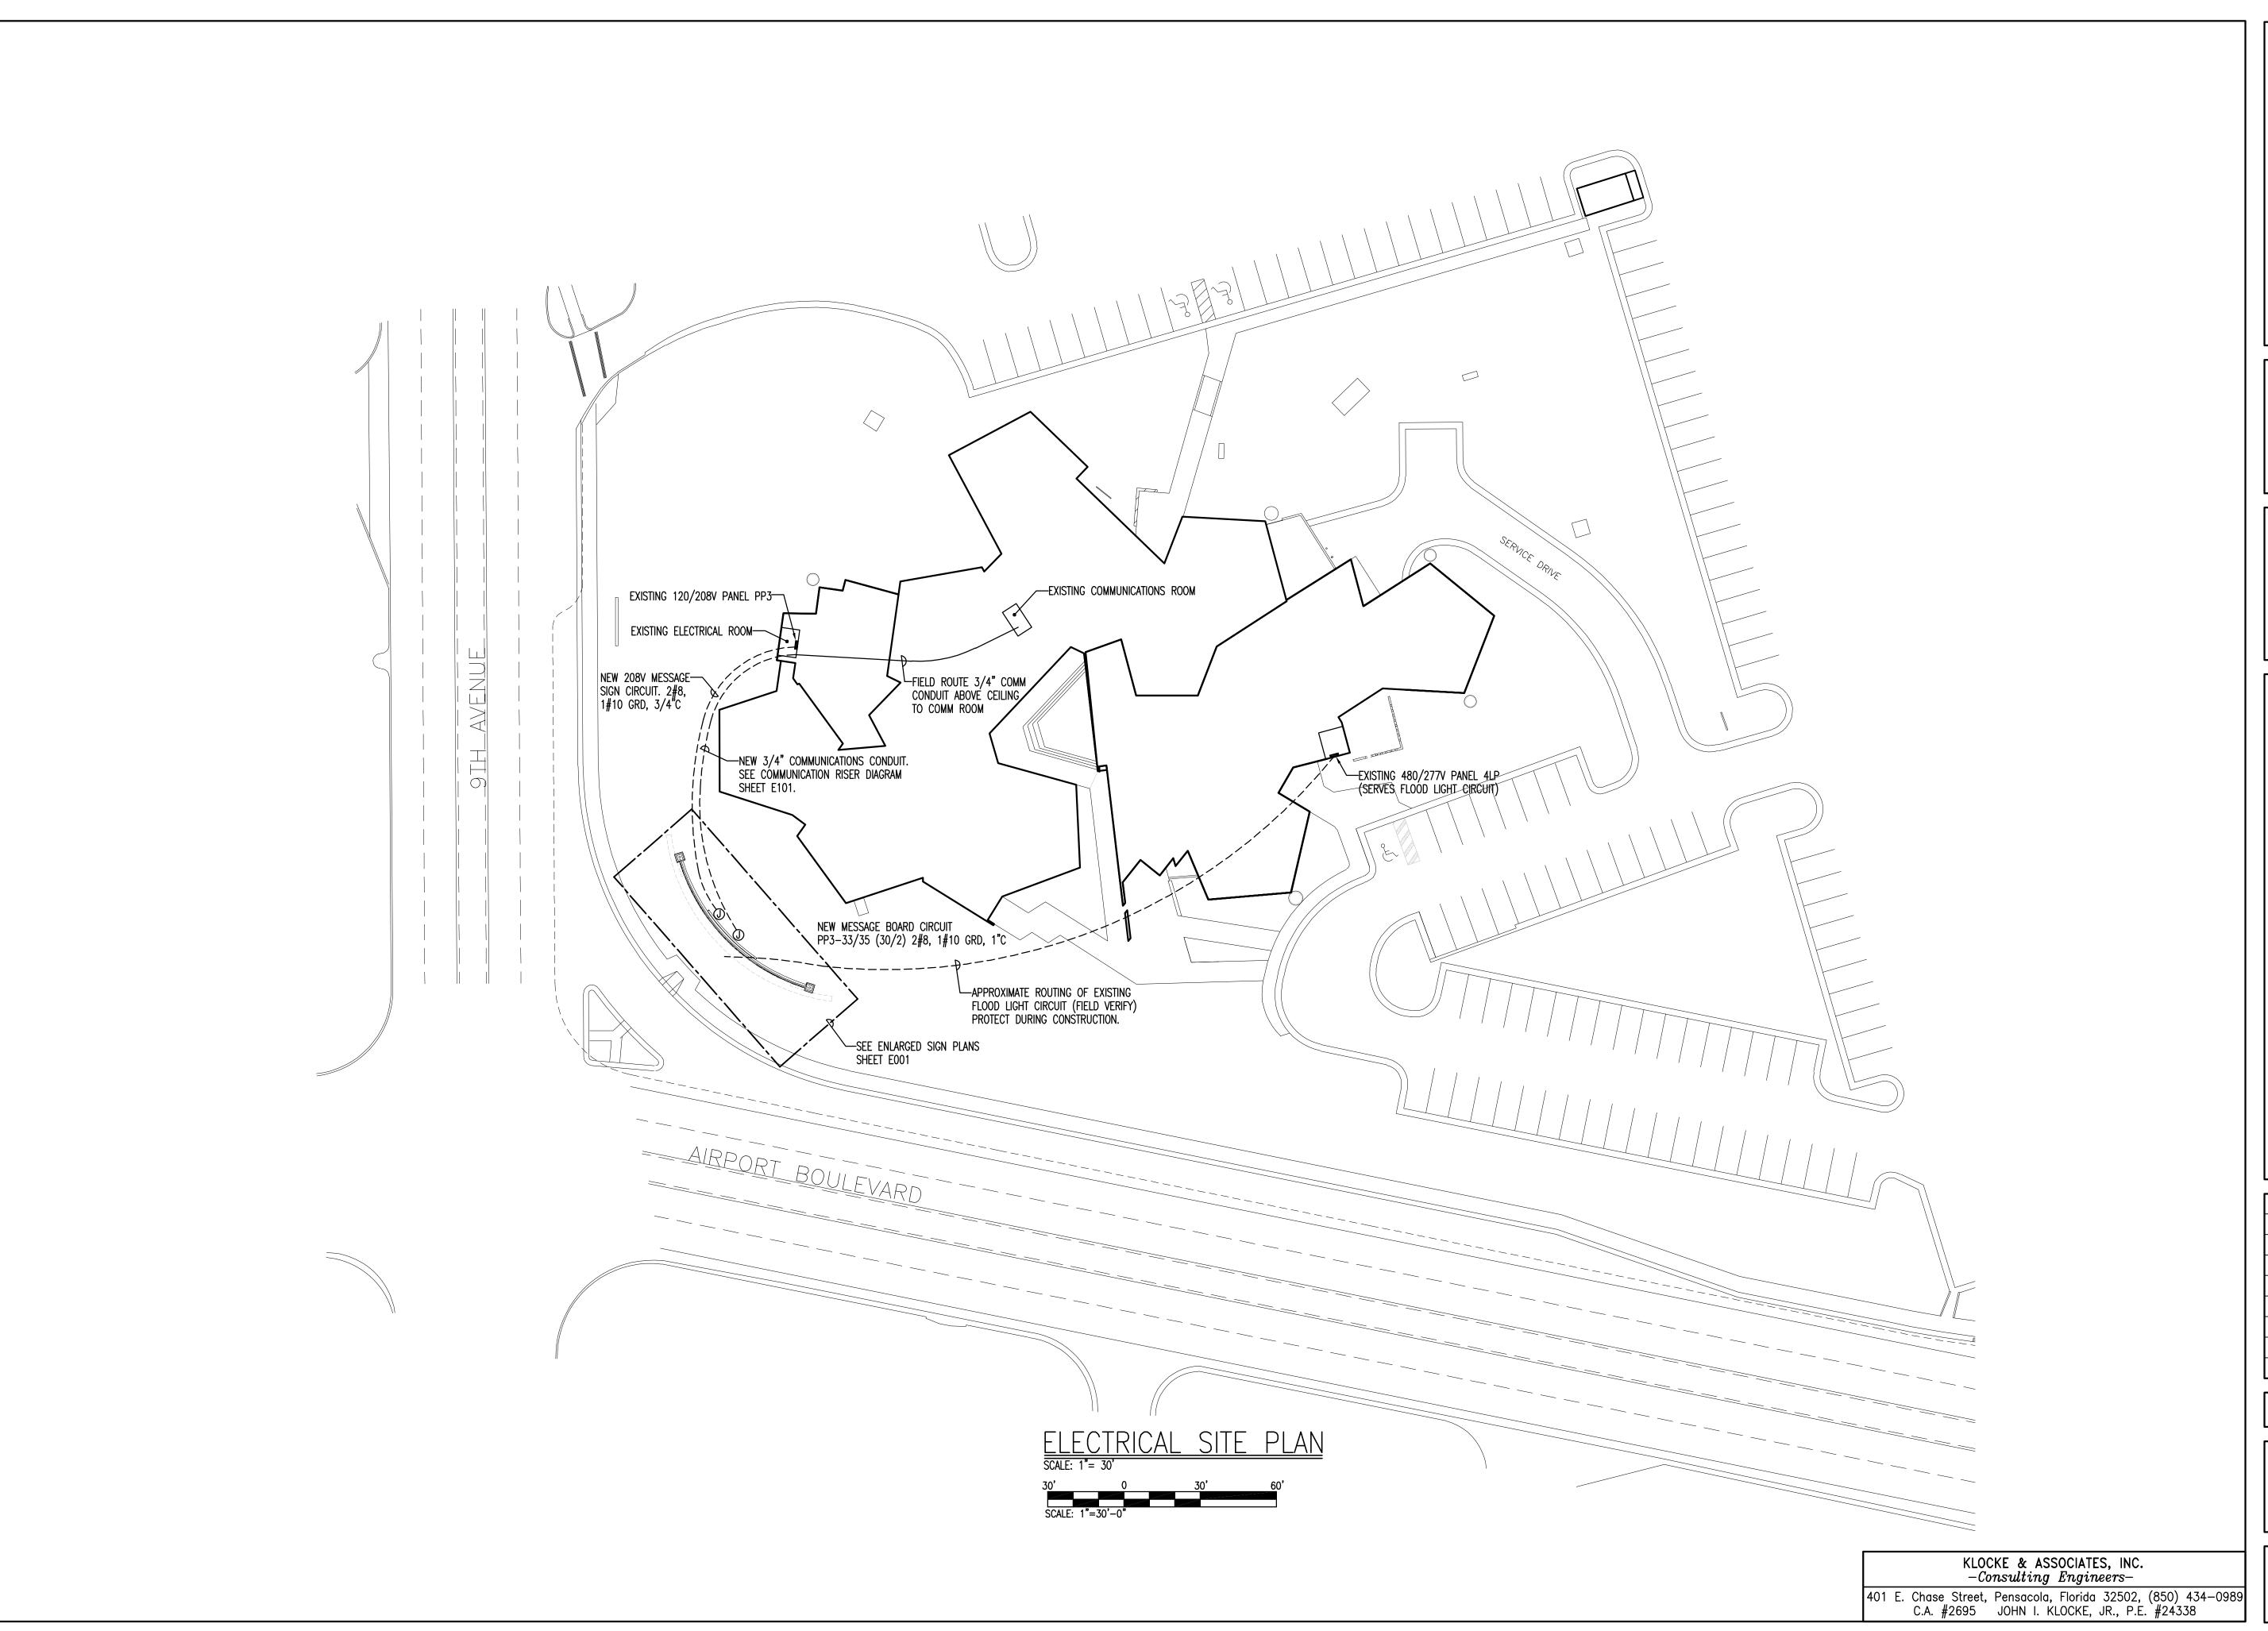

BTA
...optimizing
design value

PLANNING
ARCHITECTURE
INTERIOR DESIGN
DESIGN BUILD

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CONSTRUCTION DOCUMENTS

APRIL 11, 2012

ACOLA STATE COLLEGE -AMPUS SIGN RENOVATIO

REVISIONS:


BTA PROJECT NO: 131711.05 SHEET DATE: 04/03/12

SHEET TIT

ELECTRICAL SITE PLAN


SHEET:


E001

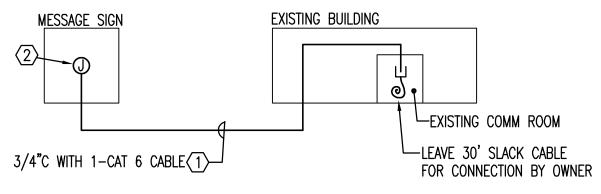


COMMUNICATIONS RISER DIAGRAM


1 CONFIRM CABLE TYPE WITH SIGN MANUFACTURER PRIOR TO START OF WORK
2 COORDINATE CONNECTION WITH SIGN MANUFACTURER

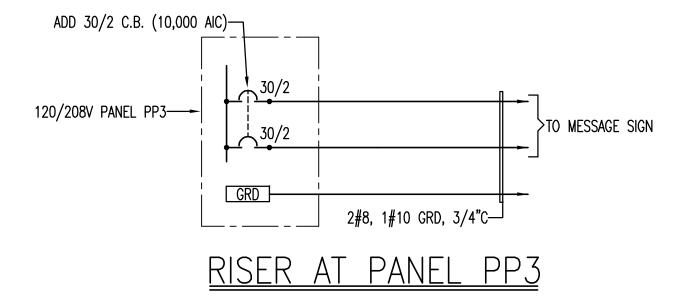

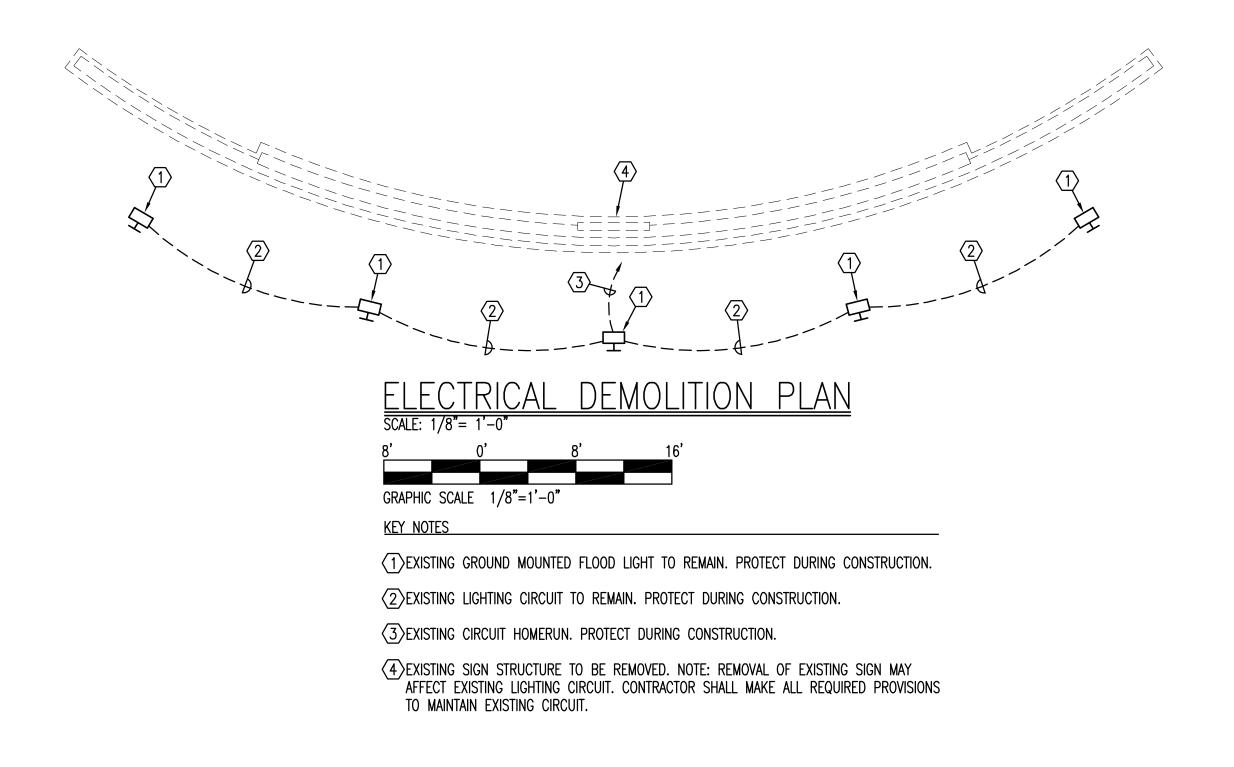

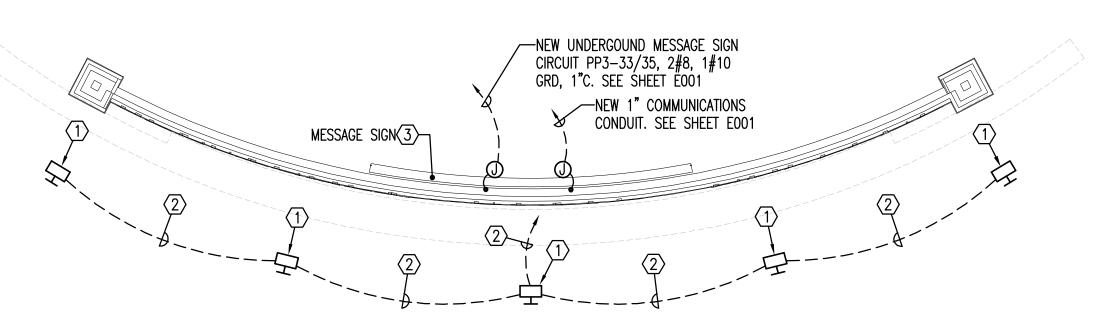

ELECTRICAL NEW WORK PLAN (FLOOD LIGHTS & MESSAGE SIGN)
SCALE: 1/8"= 1'-0"

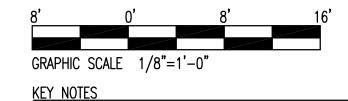

(1) EXISTING GROUND MOUNTED FLOOD LIGHT TO REMAIN. PROTECT DURING CONSTRUCTION.

(2) EXISTING LIGHTING CIRCUIT TO REMAIN. PROTECT DURING CONSTRUCTION.

3)SEE ARCHITECTURAL ELEVATION. VERIFY ALL ROUGH—IN REQUIREMENTS WITH SIGN MANUFACTURER.



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CONSTRUCTION DOCUMENTS

APRIL 11, 2012

SOLA STATE COLLEC MPUS SIGN RENOVA

REVISIONS:

 BTA PROJECT NO:
 131711.05

 SHEET DATE:
 04/03/12

ELECTRICAL
DEMOLITION AND
NEW WORK PLANS

E101

SHEET:

KLOCKE & ASSOCIATES, INC.
—Consulting Engineers—

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