

**Invitation to Bid**  
**Painting of Buildings: 10, 11, 17, & 21 Pensacola Campus**  
**5-2016/2017**



**PENSACOLA**  
S T A T E C O L L E G E

**Addendum 1**

**Question:** Would it be possible to get drawings of the buildings? It would be immensely helpful to the bidding competition as the different areas to be covered require various applications.

**Response:** Please see Attachment A. Note the drawings are for building measurements only. The exterior finish may/may not be the current finish.

**Question:** Are we painting the back side of the concrete panels that wraps around the building 11 or just the front?

**Response:** Please price both options. Noted on bid form below.

**Question:** Please advise if the following is to be re-caulked

- 1 Window Caulking – Frame to glass
- 2 Window Caulking – Frame to EIFS or Brick
- 3 Roof Coping
- 4 Roof Scuppers
- 5 Building lettering and other signage
- 6 Lighting Perimeter
- 7 Control Joints
- 8 Expansion Joints
- 9 Sidewalk to Building Joint
- 10 Door Frame Perimeter
- 11 Vents Perimeter
- 12 Dissimilar Substrate Caulk (i.e. Brick to EIFS, Brick to Concrete, etc)
- 13 Soffit to Wall
- 14 Special Joints at Building 17 Backside
- 15 Lintels (Door, Window, and Soffit)

**Response:**

- 1 Window Caulking – Frame to glass - No
- 2 Window Caulking – Frame to EIFS or Brick - Yes
- 3 Roof Coping - Yes
- 4 Roof Scuppers - Yes
- 5 Building lettering and other signage - Yes
- 6 Lighting Perimeter - Yes
- 7 Control Joints - Yes
- 8 Expansion Joints - Yes
- 9 Sidewalk to Building Joint - Yes
- 10 Door Frame Perimeter - Yes
- 11 Vents Perimeter - Yes
- 12 Dissimilar Substrate Caulk (i.e. Brick to EIFS, Brick to Concrete, etc) - Yes
- 13 Soffit to Wall - Yes
- 14 Special Joints at Building 17 Backside - Yes
- 15 Lintels (Door, Window, and Soffit) - Yes

Question: Please advise if the following is to be painted

- 1 Aluminum Windows and Storefront
- 2 Vents
- 3 Gates and Fences
- 4 Handrails
- 5 Roof Coping, Scuppers and Flashings
- 6 Greenhouse
- 7 Chillers, HVAC, or other Mechanical/Piping in Enclosed Areas
- 8 Metal Screen Walls
- 9 Decorative Metal
- 10 Lintels – Doors/Windows/Soffit
- 11 Eyebrows
- 12 Curbing and Stripping or any other Site Painting
- 13 Planter Boxes
- 14 Hazardous Waste Out Building
- 15 Corridors and Breezeways – Walls, Ceilings, and Floors
- 16 Interior Face of Service Doors
- 17 Rooftop Stucco/EIFS – Parapets
- 18 Pressure Clean Sidewalks and Concrete Flatwork
- 19 Metal Supports at Chillers and Other Mechanical Systems

Response:

- 1 Aluminum Windows and Storefront - No
- 2 Vents - No
- 3 Gates and Fences - No
- 4 Handrails - No
- 5 Roof Coping, Scuppers and Flashings - No
- 6 Greenhouse - Yes
- 7 Chillers, HVAC, or other Mechanical/Piping in Enclosed Areas - No
- 8 Metal Screen Walls - No
- 9 Decorative Metal - No
- 10 Lintels – Doors/Windows/Soffit - Yes
- 11 Eyebrows - Yes
- 12 Curbing and Stripping or any other Site Painting - No
- 13 Planter Boxes - Yes
- 14 Hazardous Waste Out Building - Yes
- 15 Corridors and Breezeways – Walls, Ceilings, and Floors – Walls and Ceilings
- 16 Interior Face of Service Doors - No
- 17 Rooftop Stucco/EIFS – Parapets - Yes
- 18 Pressure Clean Sidewalks and Concrete Flatwork - No
- 19 Metal Supports at Chillers and Other Mechanical Systems - No

Question: Do all surfaces receive Tersus Color Coat?

Response: All EIFS receive Tersus Color Coat.

Question: Is there any extended warranty?

Response: No

Question: Are equals to Tersus allowed?

Response: Bidder may submit an equivalent manufacturer. If submitted an equivalent product, please include documentation on the product. The College will be the ultimate determiner of equivalency and may consult with the vendor and/or other parties to determine equivalency.

Question: Please confirm bid bonds are required.

Response: As noted in section, 1.11 of the specifications, "A bid bond or deposit, in the amount of five percent (5%) of the base bid will be required to accompany each bid, as guarantee that the successful bidder, will enter into a contract with the Owner, if desired by same. Any deposit must be in the form of a Certified Check, or a Cashier's Check. The bid bond or deposit will be held as liquidated damages, in the event that the successful bidder refuses to enter into a contract with the Owner."

Question: Can we offer discounts for award of multiple buildings?

Response: Yes, please indicate the cost of each building separately and then input the discount structure for the award of multiple buildings as indicated on the revised bid form below.

Question: Will power and water be provided by the owner?

Response: Yes

Question: Will the contractor be required to provide sanitary toilets for their workers?

Response: Yes

Question: Will contractor be required to provide temporary [ingress and] egress into [and out of] the buildings through the fencing required per Spec page 6, 3.09?

Response: Yes

Question: Can floor plans of the building[s] be provided?

Response: See Attachment B

Question: What are the permissible work hours? – No limitation on work hours.

Response: No limitation on work hours

Question: Can aerial lifts be brought on site?

Response: Yes

Question: [Follow up to above question] Are there height restrictions due to proximity to airport?

Response: No

**BID FORM**

Total Lump Sum Cost as specified building 10 \$ \_\_\_\_\_

Total Lump Sum Cost as specified building 11 \$ \_\_\_\_\_

Total Lump Sum Cost as specified building 17 \$ \_\_\_\_\_

Total Lump Sum Cost as specified building 21 \$ \_\_\_\_\_

Payment Terms: Net 30 days or prompt payment discount of \_\_\_\_\_%, \_\_\_\_\_ Days offered by Proposer.

Discount percentage provided for award of Building 10 & 11 \_\_\_\_\_%

Discount percentage provided for award of Building 10 & 17 \_\_\_\_\_%

Discount percentage provided for award of Building 10 & 21 \_\_\_\_\_%

Discount percentage provided for award of Building 11 & 17 \_\_\_\_\_%

Discount percentage provided for award of Building 11 & 21 \_\_\_\_\_%

Discount percentage provided for award of Building 17 & 21 \_\_\_\_\_%

Discount percentage provided for award of Building 10, 11, & 17 \_\_\_\_\_%

Discount percentage provided for award of Building 10, 11, & 21 \_\_\_\_\_%

Discount percentage provided for award of Building 10, 17, & 21 \_\_\_\_\_%

Discount percentage provided for award of Building 11, 17, & 21 \_\_\_\_\_%

Discount percentage provided for award of Building 10, 11, 17, 21 \_\_\_\_\_%

**Include tentative schedule with bid.**


Firm

\_\_\_\_\_  
Authorized Agent Name


\_\_\_\_\_  
Signature

\_\_\_\_\_  
Date


Firms certify by their signature they have read and understand the conditions and specifications of this Invitation to Bid and they have the authority, capacity, and capability to perform all conditions and specifications of this Invitation to Bid.

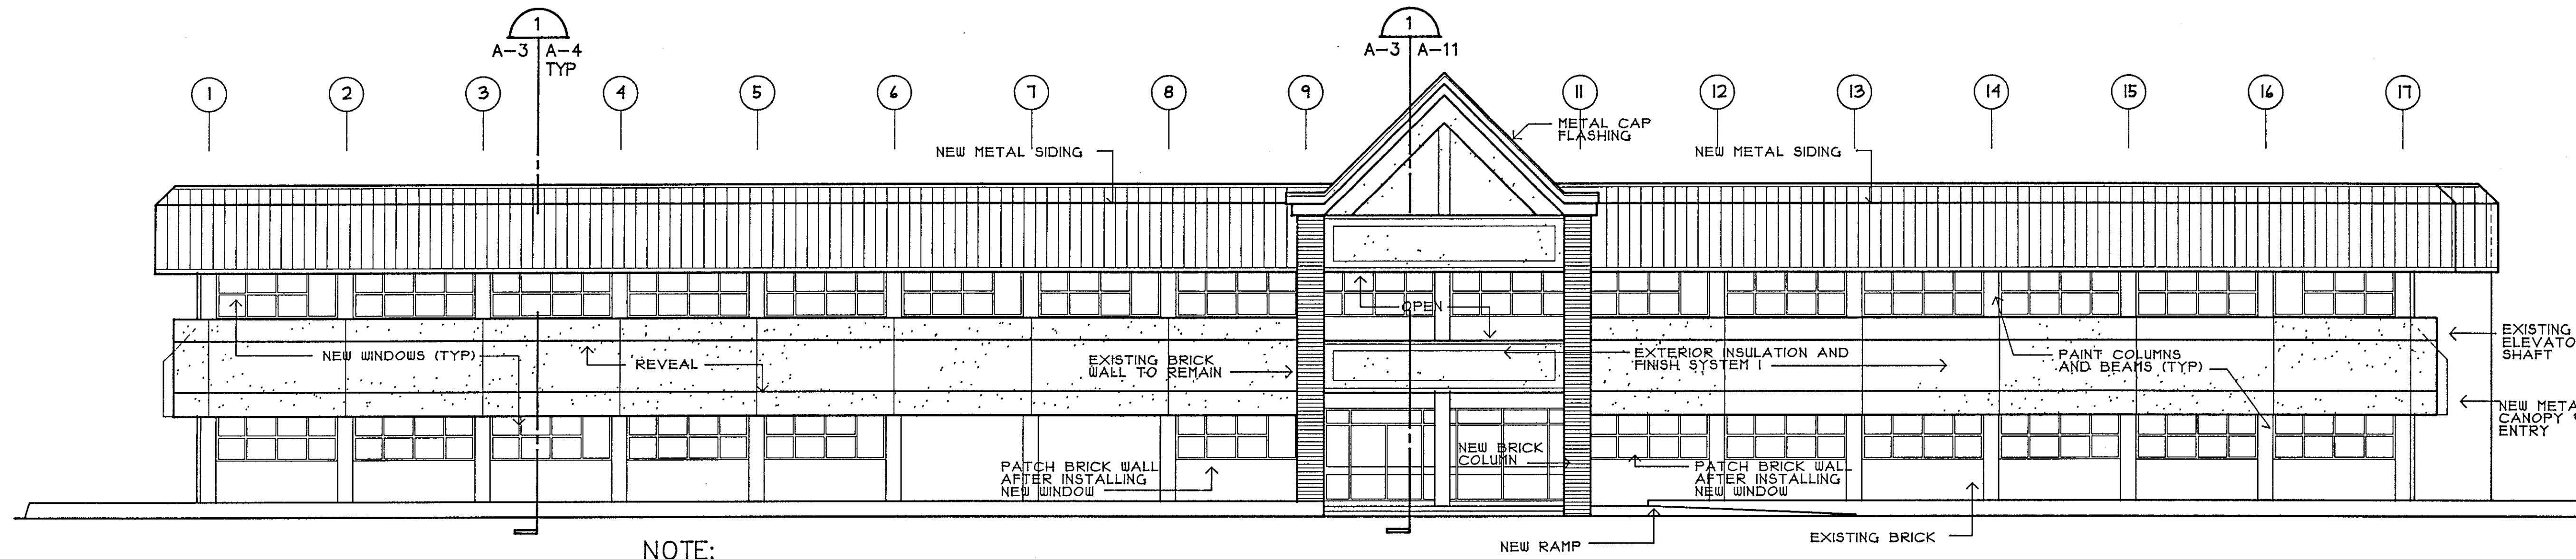


**NORTH ELEVATION**  
SCALE 1/8"=1'-0"

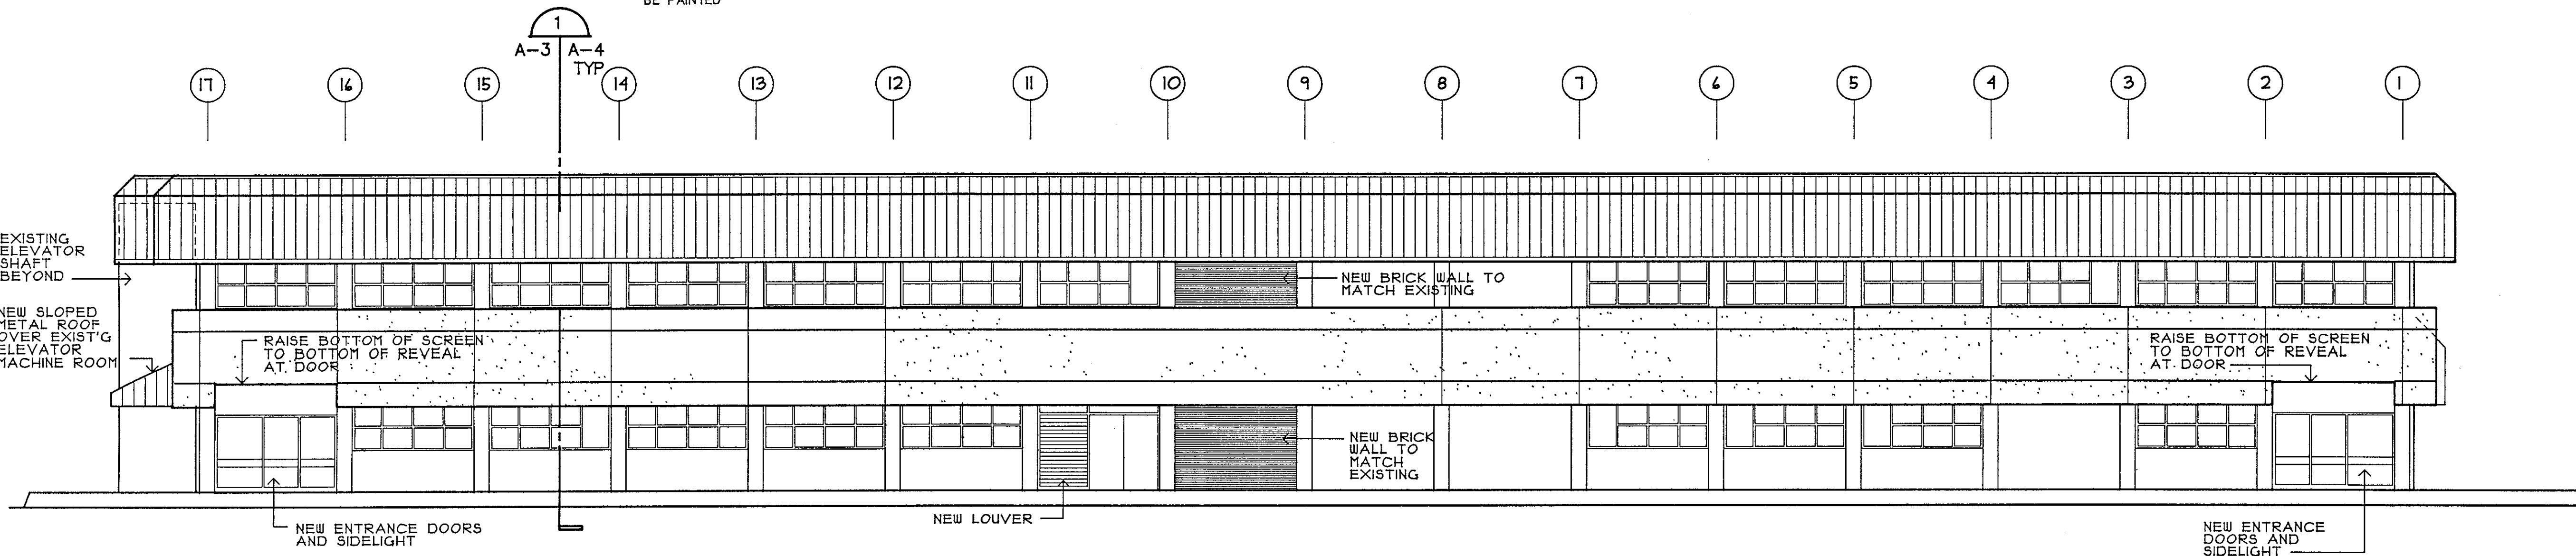


**SOUTH ELEVATION** (SEE NORTH ELEVATION FOR MATERIALS)  
SCALE 1/8"=1'-0"

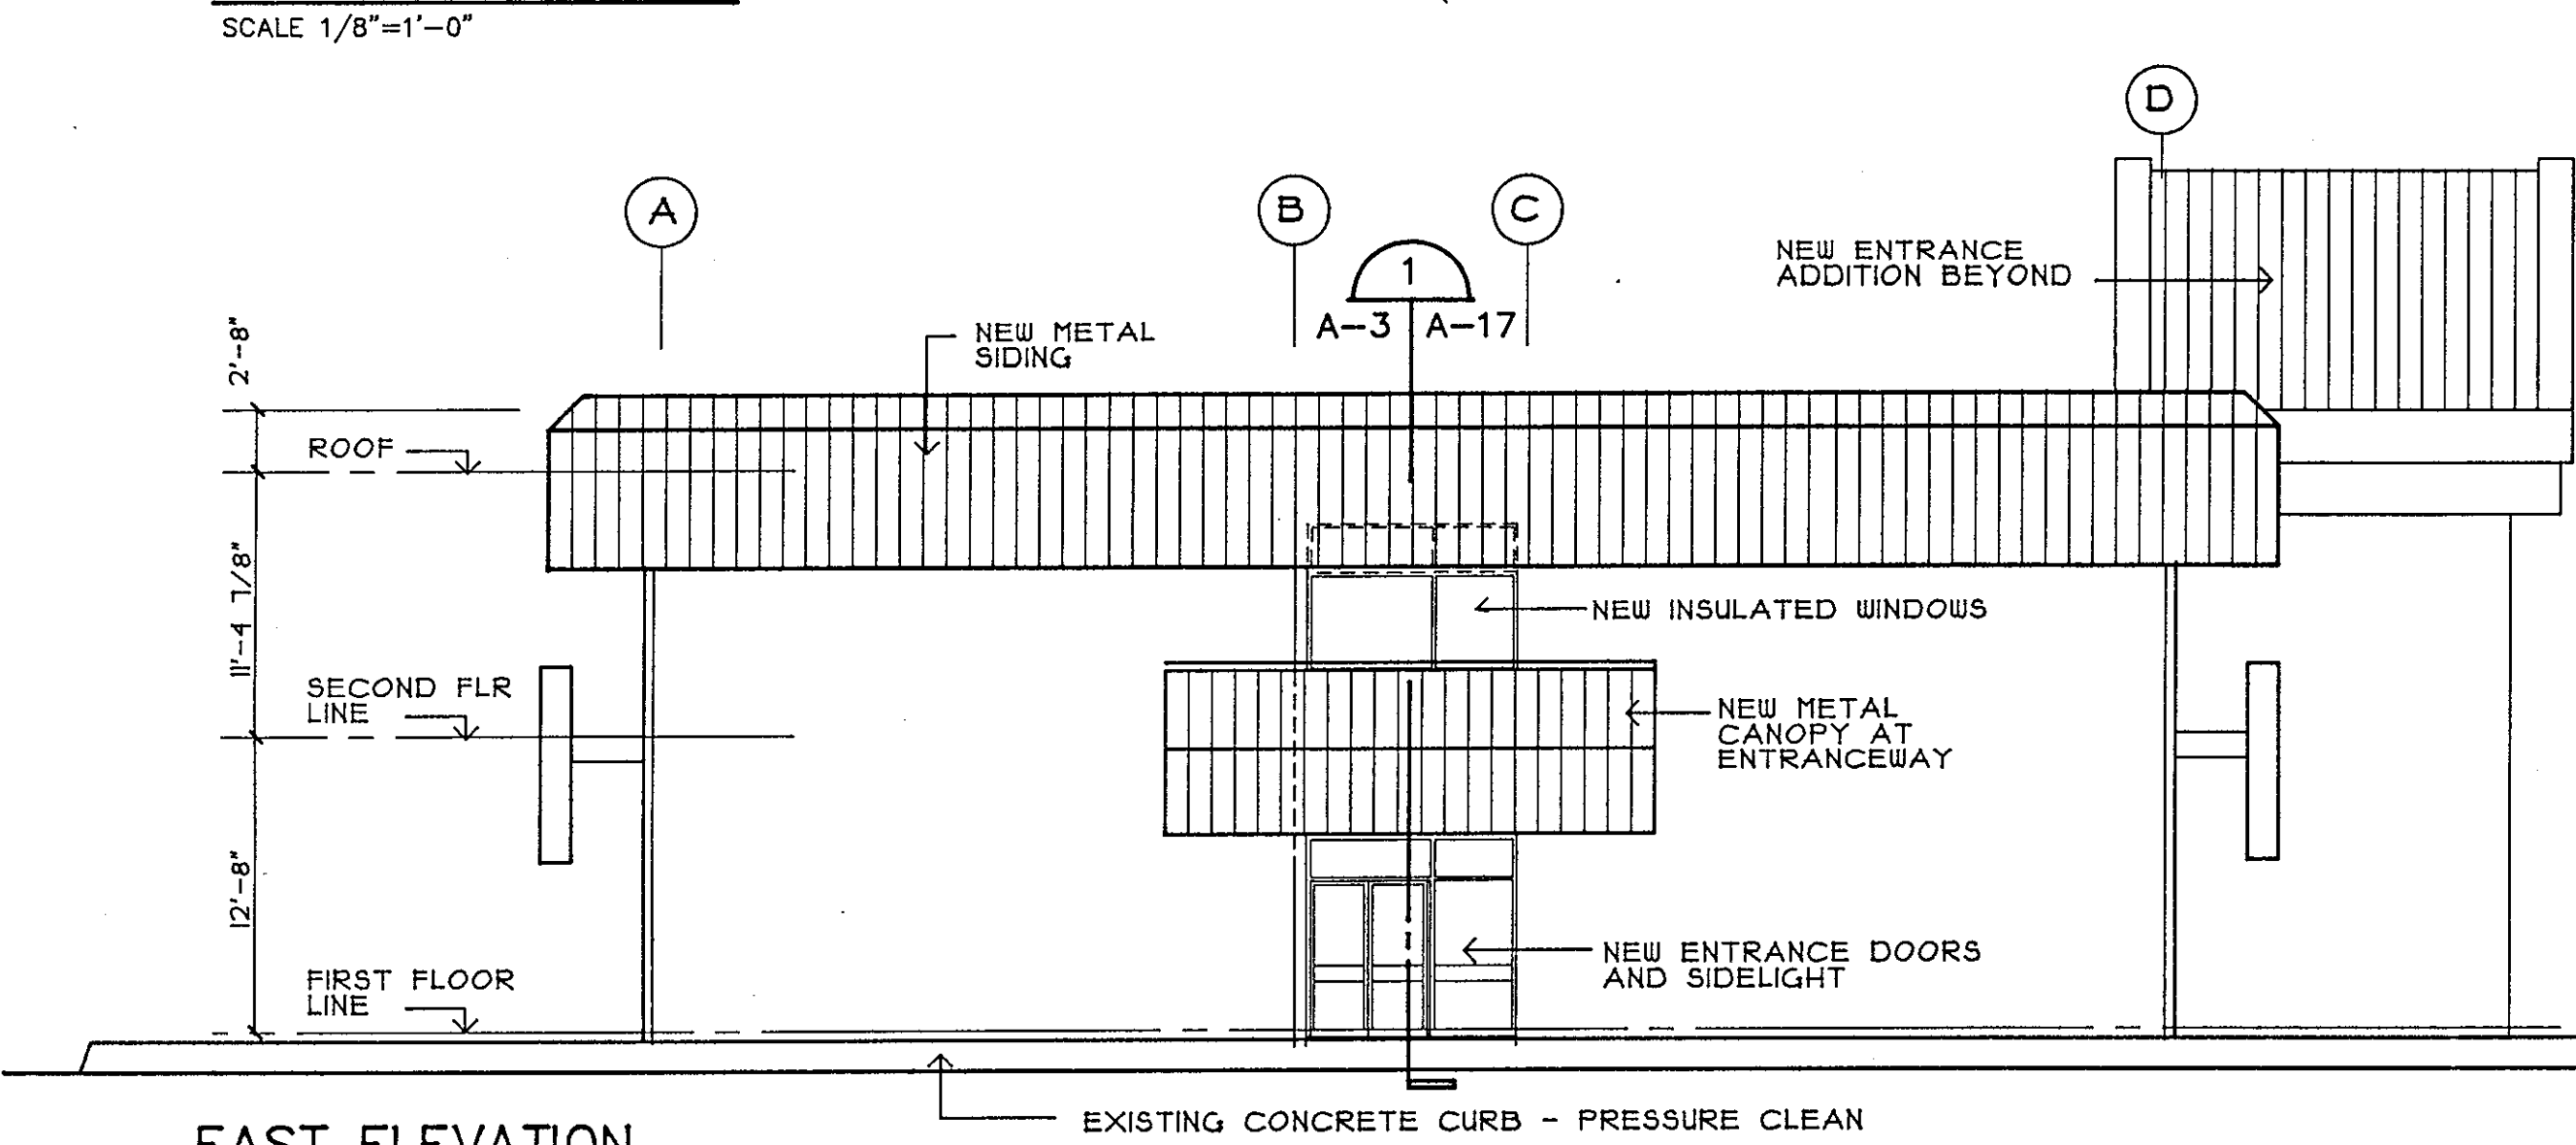

**EAST ELEVATION**  
SCALE 1/8"=1'-0"

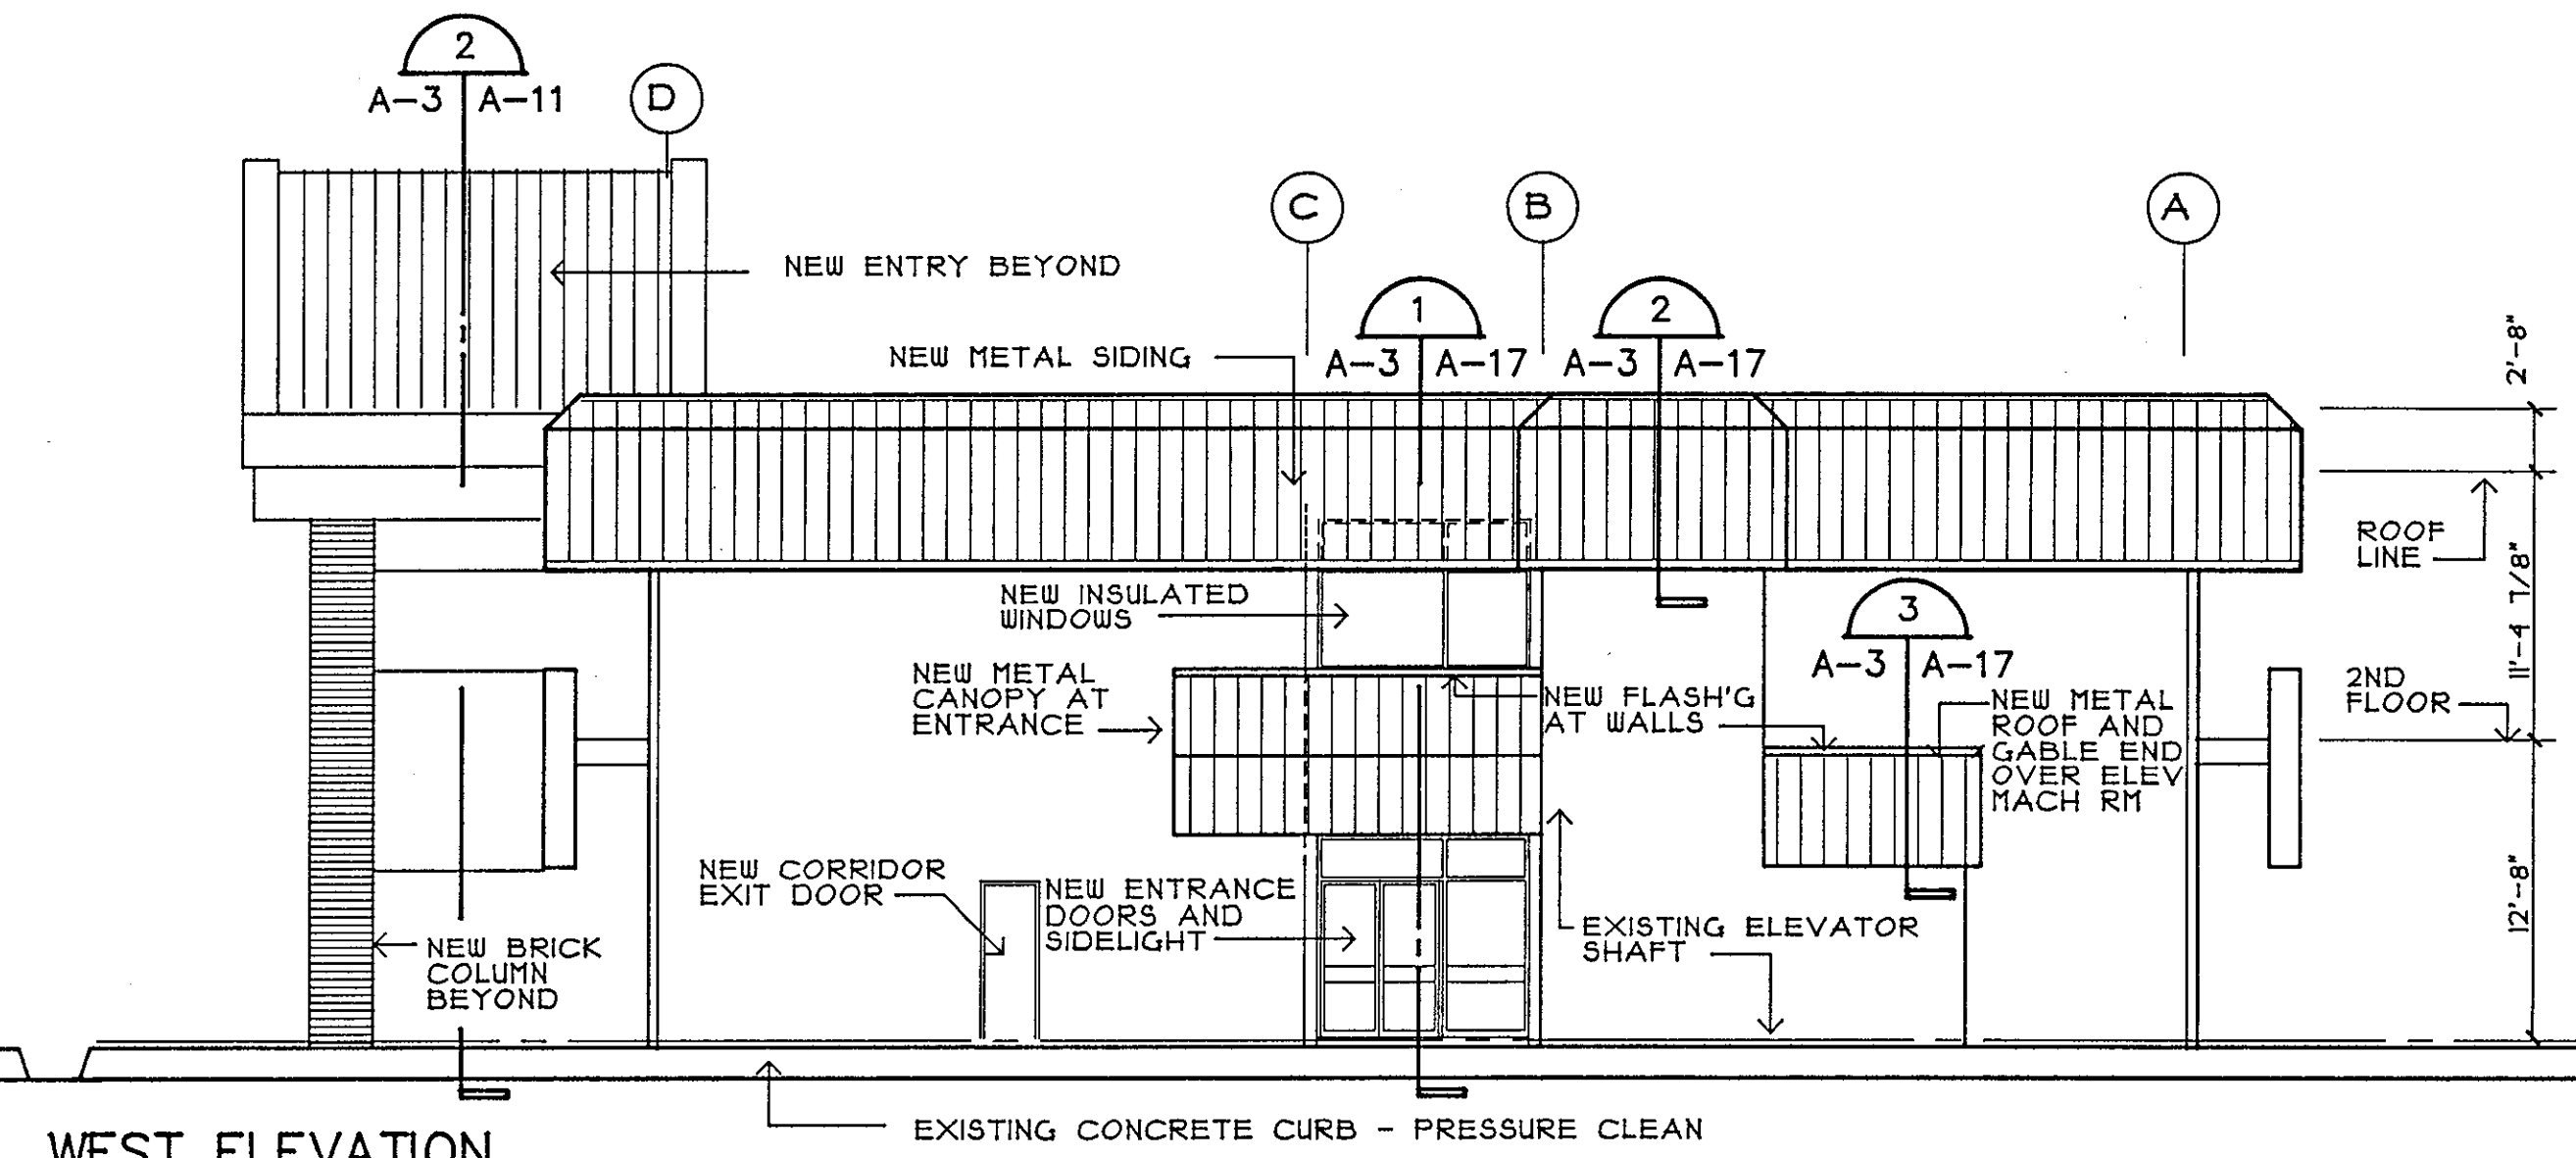


**WEST ELEVATION**  
SCALE 1/8"=1'-0"

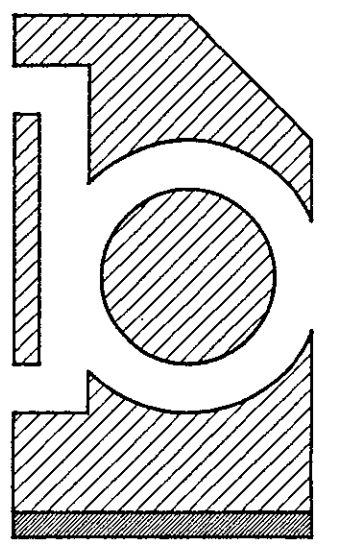

BAY DESIGN ASSOCIATES


DESIGN : WJS	JOB NO : 1170	PROJECT: RENOVATIONS AND ALTERATIONS - BUSINESS EDUCATION BUILDING 10 PENSACOLA JUNIOR COLLEGE PENSACOLA CAMPUS
DRAWN : WJS	FILE NO : 170A3	
CHECKED : GSJ	DATE : NOVEMBER 17, 1992	
REVISION :		
ARCHITECTS ■ PLANNERS ■ 102 EAST GARDEN STREET ■ PENSACOLA, FLORIDA 32501		SHEET TITLE: NEW EXTERIOR ELEVATIONS
■ (904) 432-0706 ■ (904) 433-0508		

SHEET NO :  
**A-3**

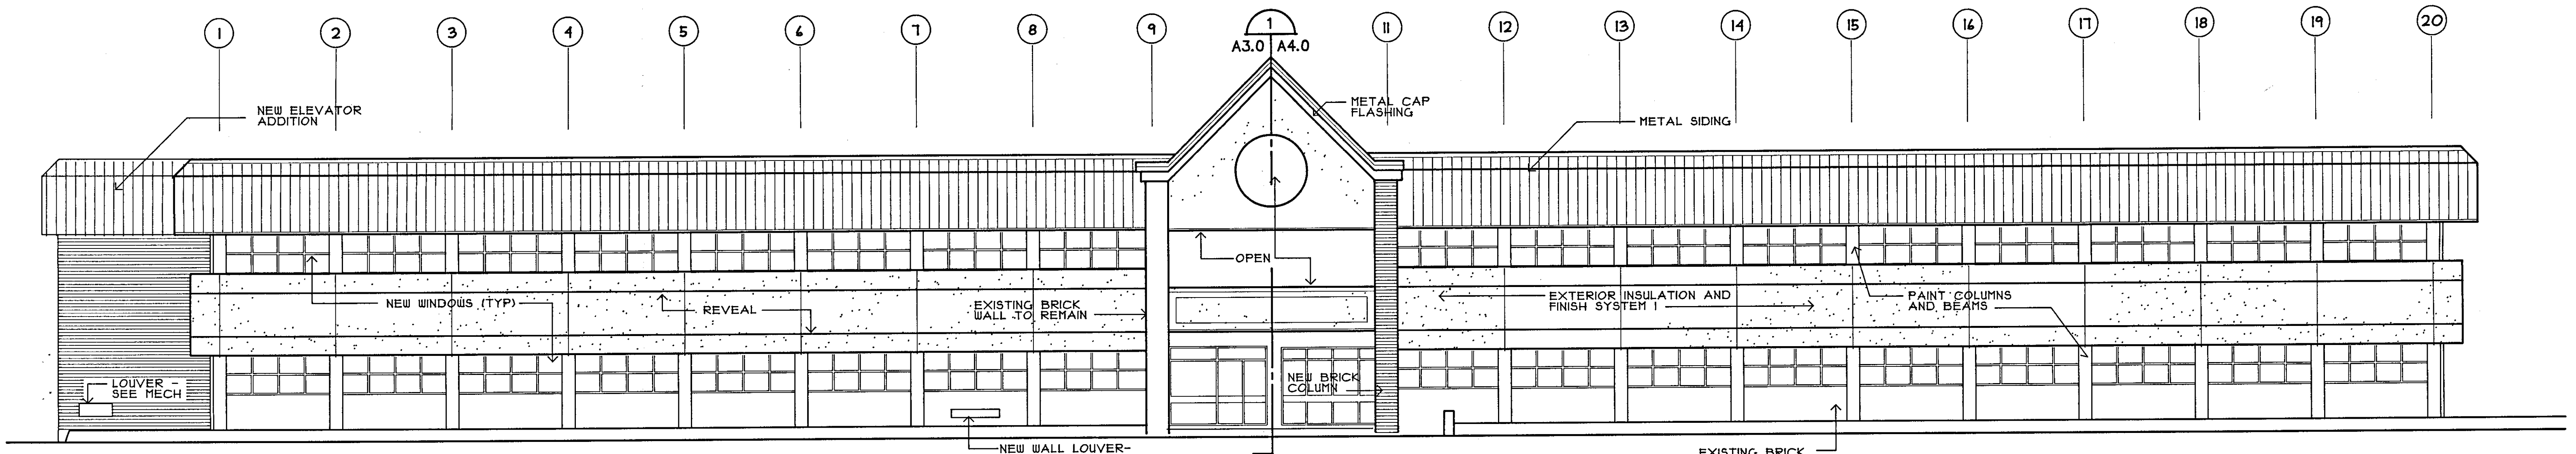


**NORTH ELEVATION**  
SCALE 1/8"=1'-0"


**NOTE:**  
ALL EXTERIOR CONCRETE COLUMNS, BEAMS, AND OTHER EXPOSED SURFACES SHALL BE PAINTED

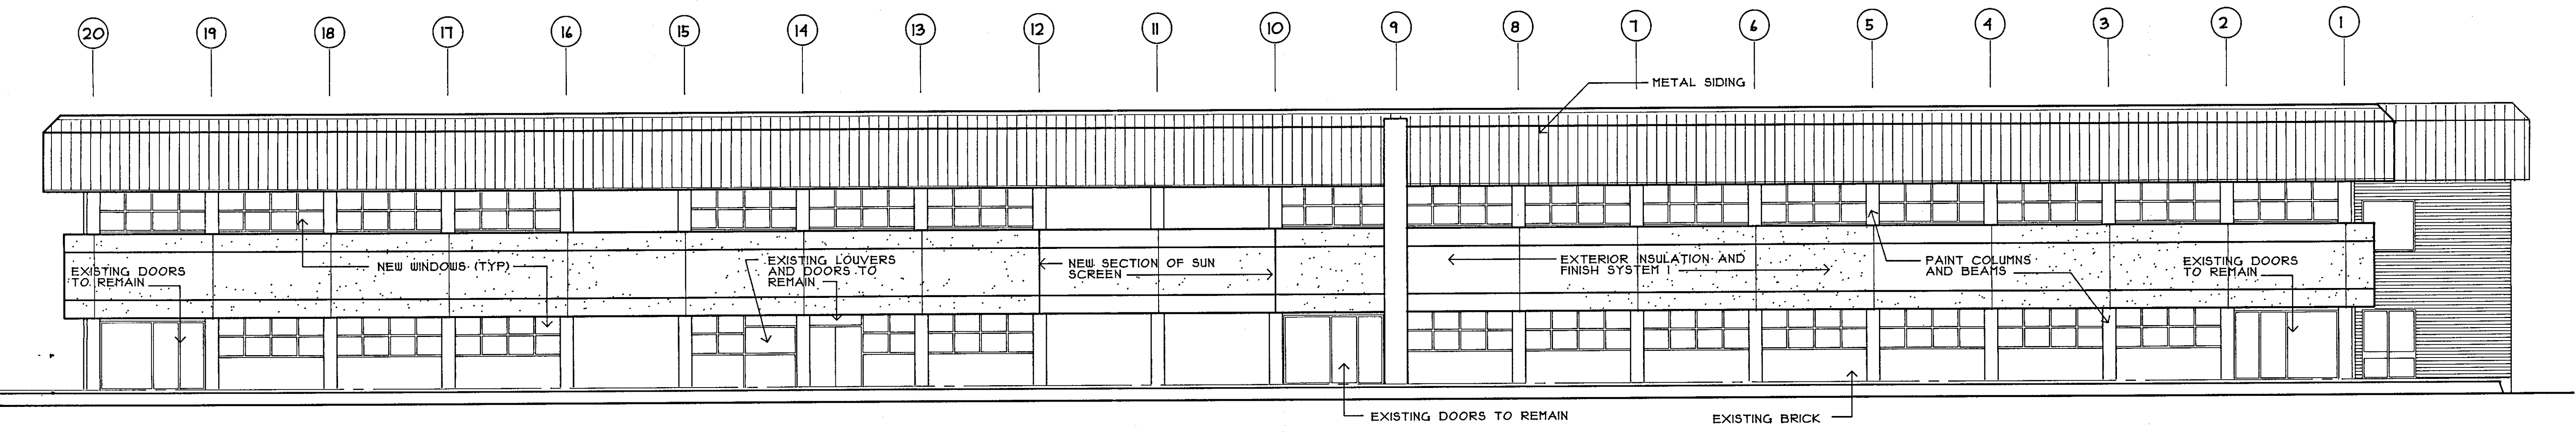

**SOUTH ELEVATION**  
SCALE 1/8"=1'-0"

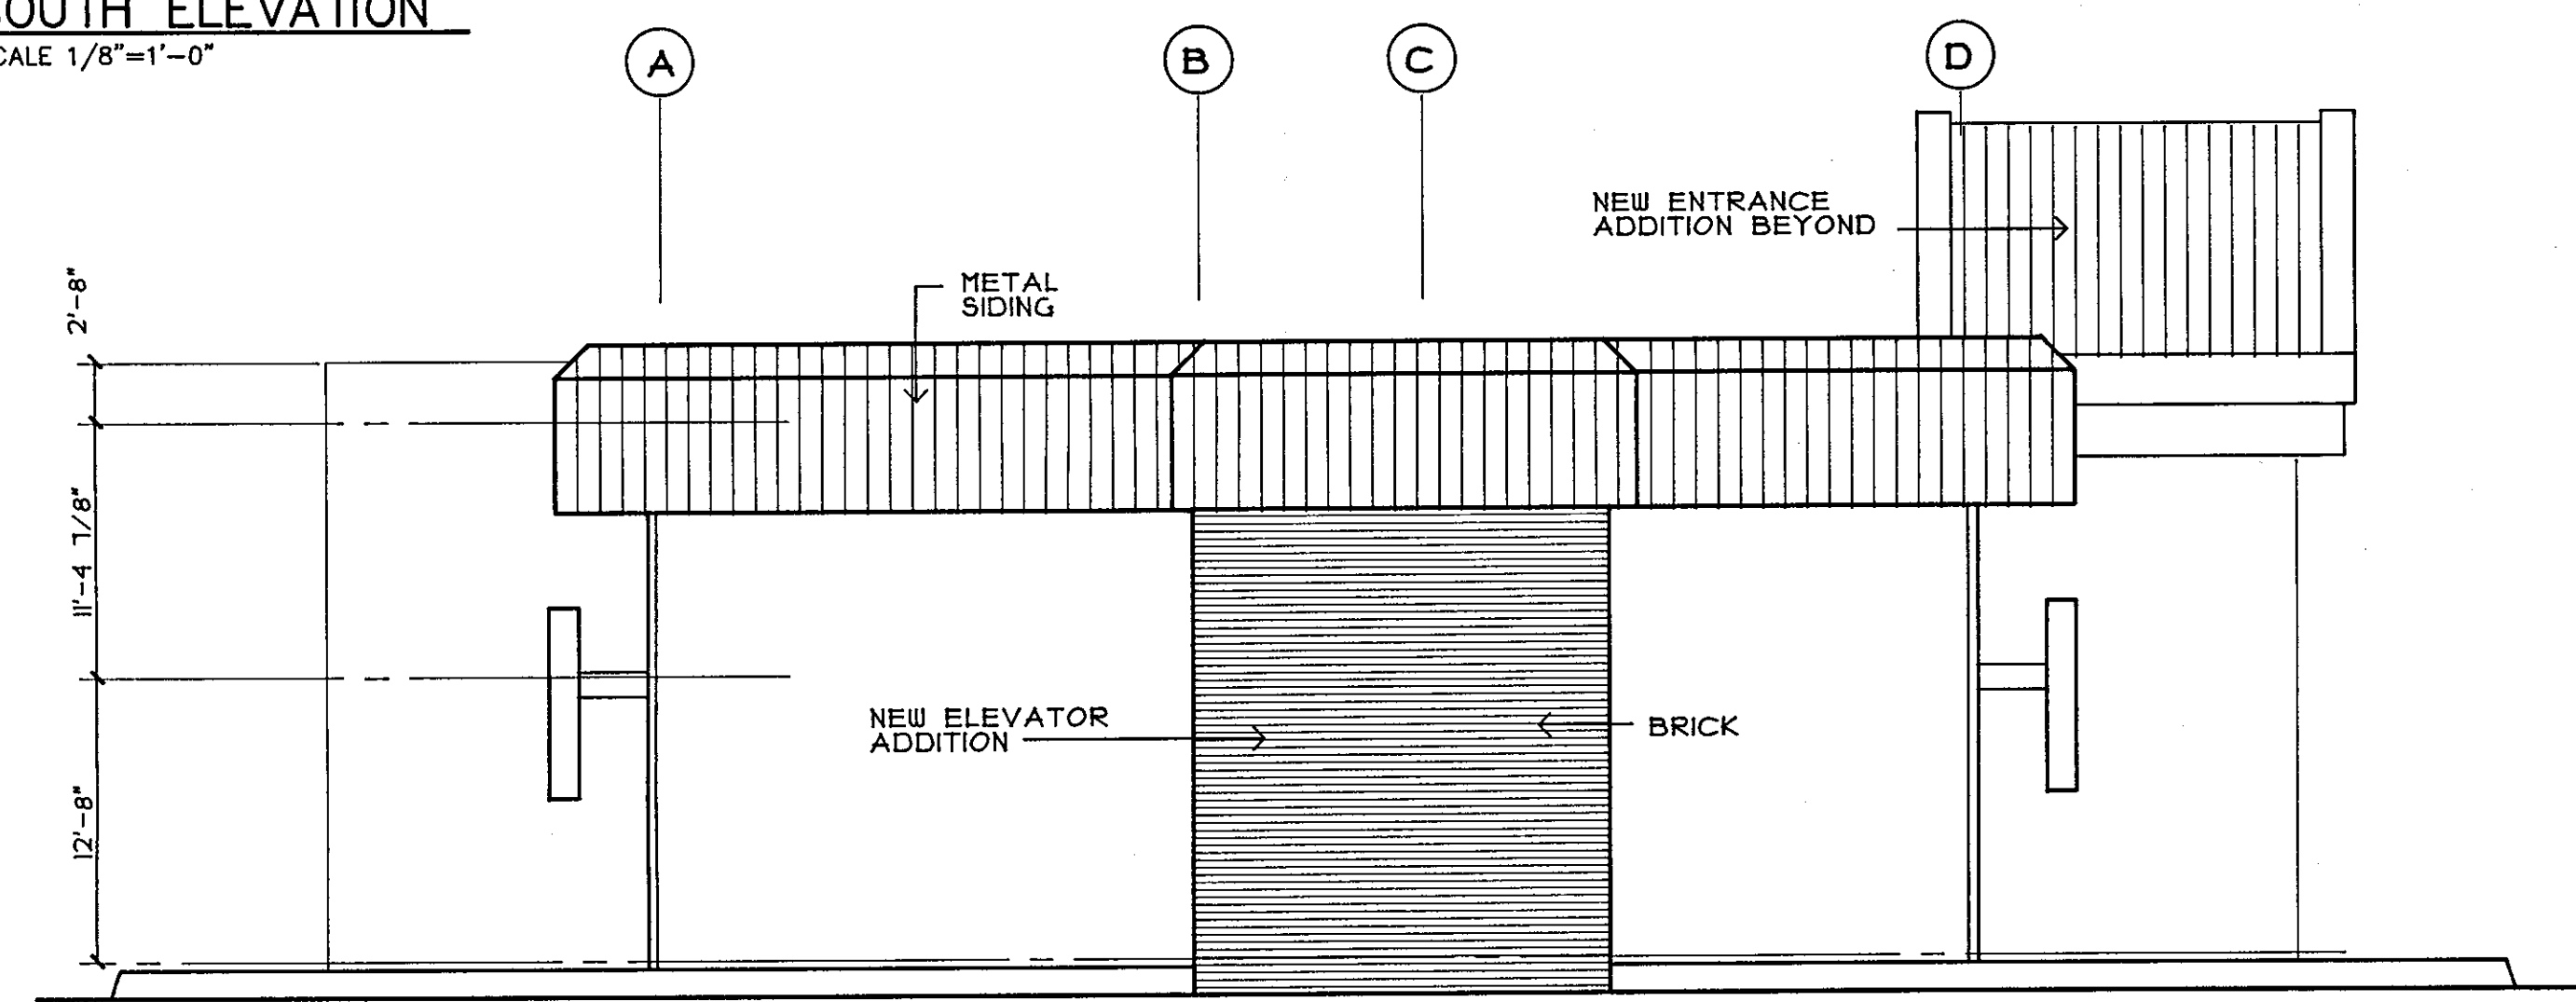

**EAST ELEVATION**  
SCALE 1/8"=1'-0"

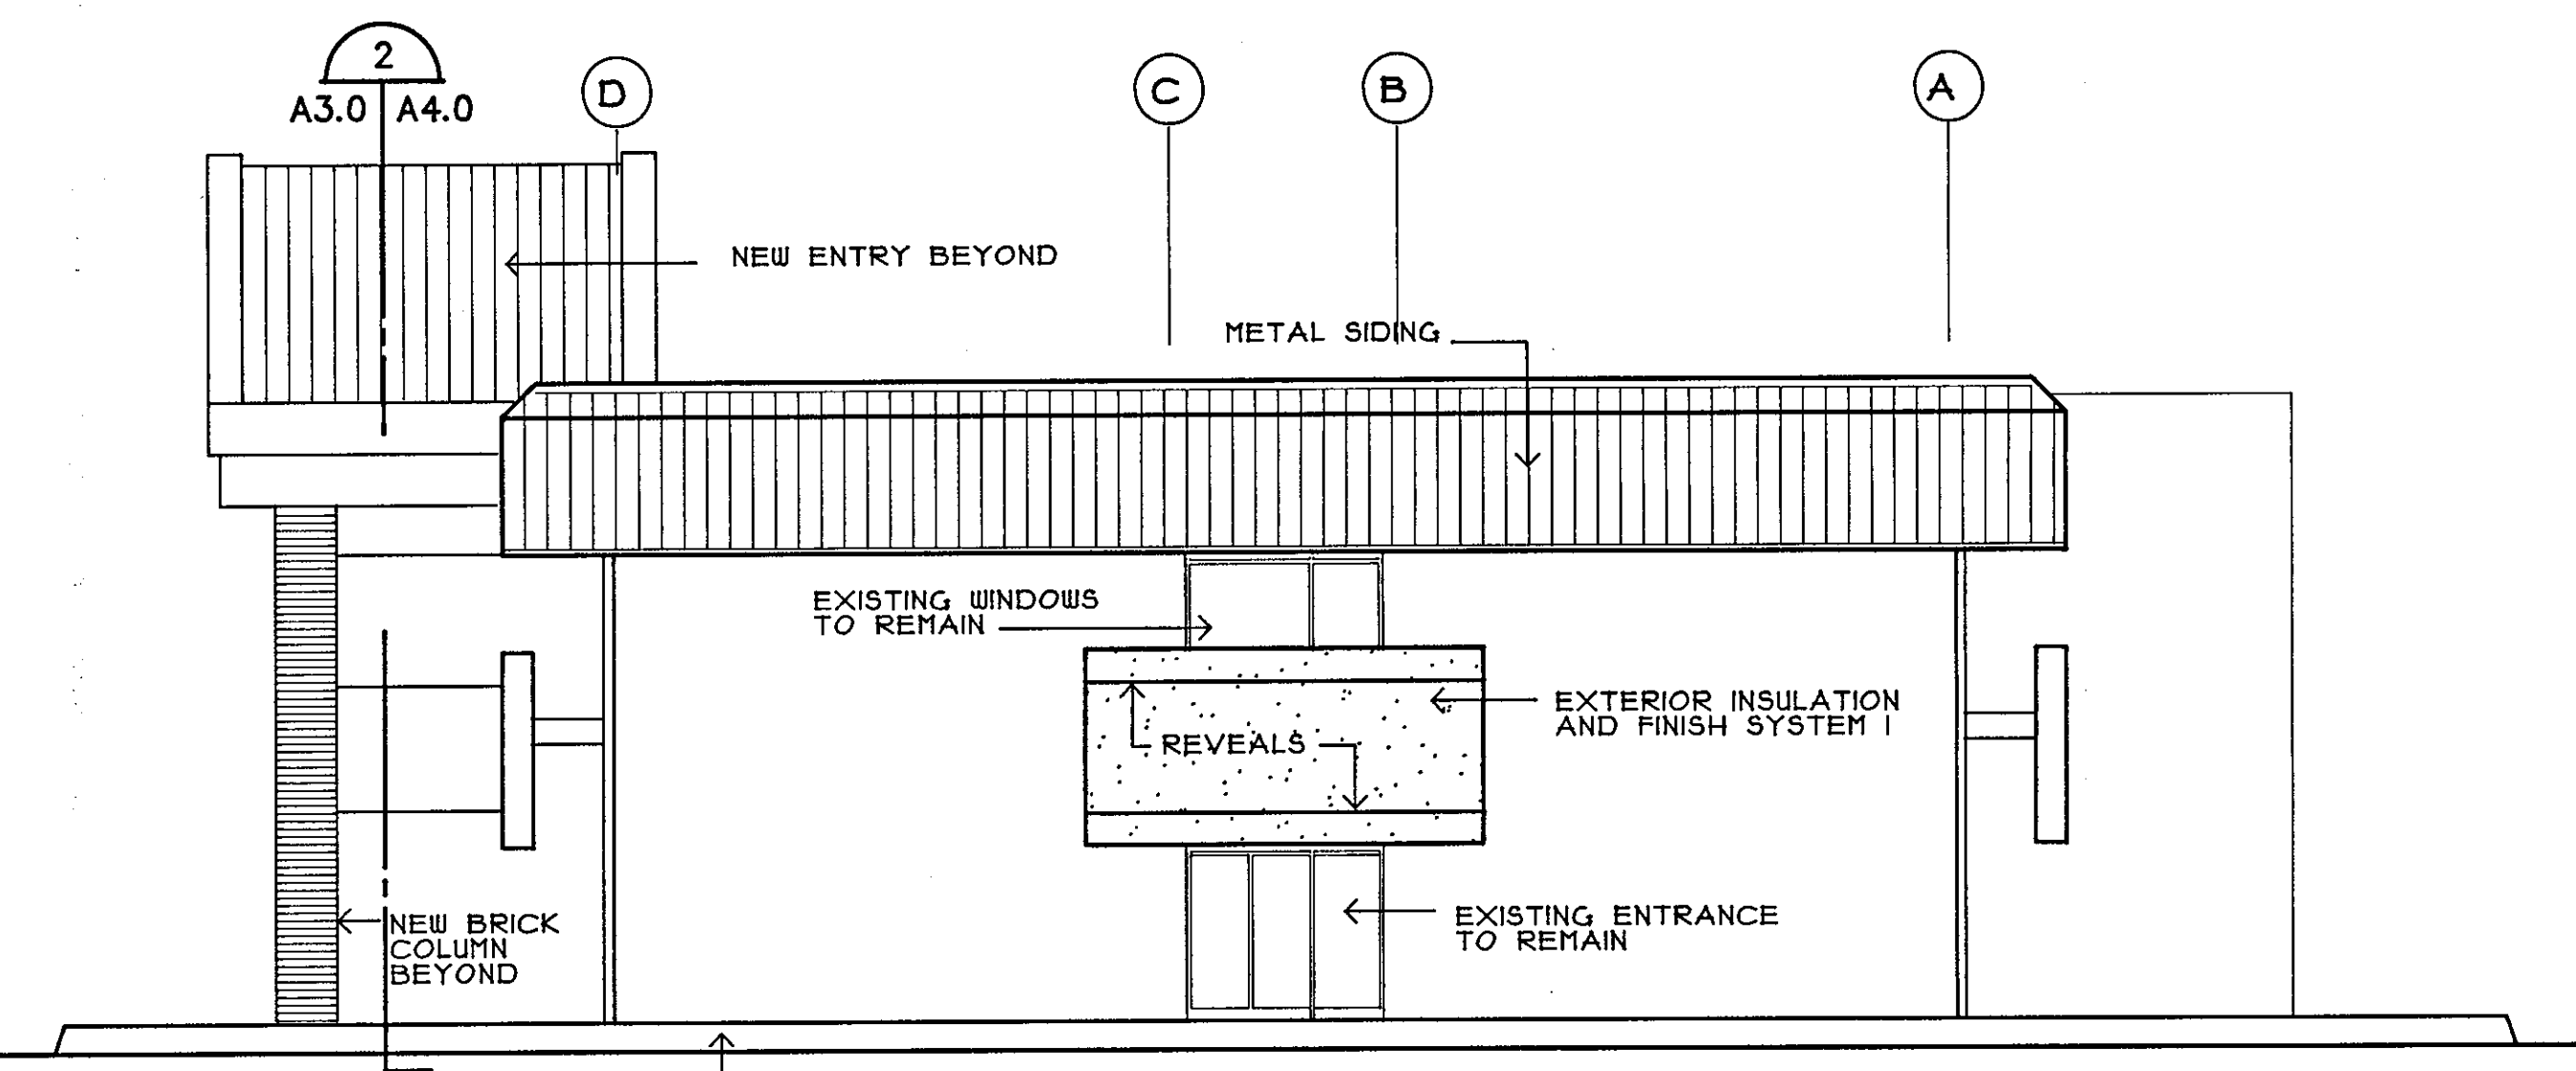

**WEST ELEVATION**  
SCALE 1/8"=1'-0"


WALTER J. SMITH, ARCHITECT  
102 EAST GARDEN STREET  
PENSACOLA, FL 32501  
(904) 432-0706  
JANUARY 21, 1992

PROJECT  
RENOVATIONS TO BLDG 11  
ADULT HIGH SCHOOL  
PENSACOLA JUNIOR COLLEGE  
PENSACOLA, FL  
PROJECT NO. 1130B  
FILE NO. 130B4A  
DRAWN BY J. PHILLIPS  
CHECKED BY W. SMITH

SHEET TITLE  
**NEW  
EXTERIOR  
ELEVATIONS**

DRAWING NUMBER  
**A-3.0**



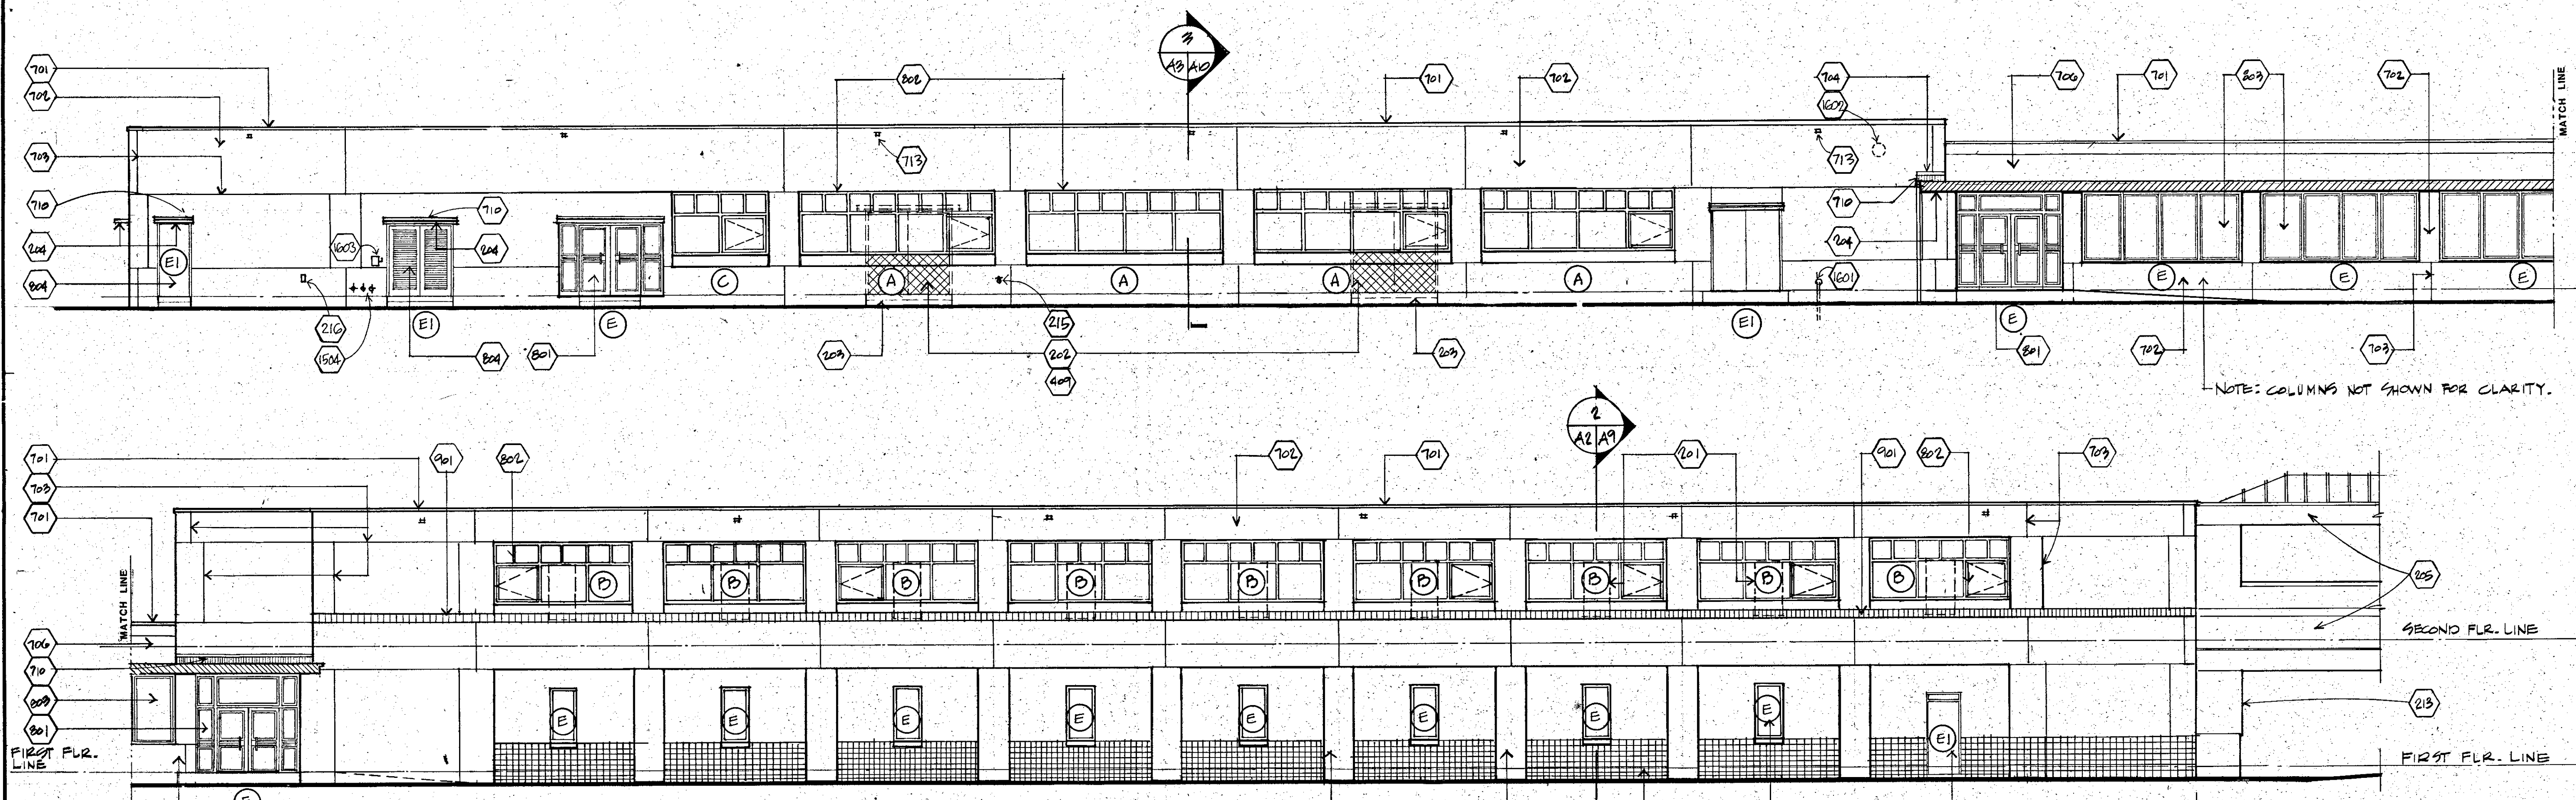

**NORTH ELEVATION**  
SCALE = 1/8" = 1'-0"

**WEST ELEVATION**  
SCALE = 1/8" = 1'-0"

**EAST ELEVATION**  
SCALE = 1/8" = 1'-0"

**KEY PLAN** no scale

NOTE: COLUMNS NOT SHOWN FOR CLARITY.

EXIST. CONSTRUCTION RENOVATION  
EXIST. CONSTRUCTION NO WORK, U.N.C.

NOTE: COLUMN NOT SHOWN FOR CLARITY.

**KEYNOTES**

**DIVISION TWO: SITE WORK**

- 201 - Demolish existing window and frame, complete.
- 202 - Demolish existing door and frame, complete.
- 203 - Demolish existing concrete steps, complete.
- 204 - Existing canopy to remain.
- 205 - Existing walk way to remain, no work.
- 206 - Demolish existing masonry to receive window.
- 207 - Demolish existing wall, patch floor and ceiling to receive new finish as indicated.
- 208 - Demolish existing brick veneer.
- 209 - Demolish existing exterior canopy.
- 210 - Demolish existing precast concrete coping.
- 211 - Demolish existing casework to the extent indicated, patch wall to match existing.
- 212 - Unless otherwise noted, demolish 5'-0" strip of existing ceiling along exterior wall as shown. Support and protect remaining ceiling as required. Replace with new acoustical tile to match existing.
- 213 - Existing wing-wall to remain. Modify as indicated.
- 214 - Existing aerial to remain.
- 215 - Existing hose bibb extend to face of new finish, see mechanical.
- 216 - Existing wall receptacle. Extend to face of new finish, see electrical.
- 217 - Existing clean-out to remain, see mechanical.
- 218 - Demolish plumbing fixtures, cut and cap utilities. Conceal in wall or floor.
- 219 - Demolish existing wood paneling and wall furring.
- 220 - Demolish existing masonry to receive door and frame, patch to match existing.
- 221 - Demolish door, frame to remain, paint.
- 222 - Existing concrete to remain.
- 223 - Compacted fill.
- 224 - Demolish existing quarry tile.
- 225 - Existing 4" PVC drain to remain.

**DIVISION FOUR: MASONRY**

- 401 - Cast stone sill.
- 402 - Fill opening with masonry to match, paint.
- 403 - Existing brick to remain.
- 404 - Existing concrete masonry units to remain.
- 405 - Cast stone panels to remain.
- 406 - Brick to match existing.
- 407 - Decorative brick to match existing.
- 408 - Masonry anchors # 24" O.C.
- 409 - Infill opening below new window with masonry to match, paint.
- 410 - 6" U-block, cut down as required.

**DIVISION SEVEN: THERMAL AND MOISTURE PROTECTION**

- 701 - Prefabricated aluminum coping.
- 702 - Exterior insulation and finish system.
- 703 - Control joint, see detail 5/A8.
- 704 - 0.032" Aluminum counter flashing.
- 705 - Not Used.
- 706 - Foam roof to remain.
- 707 - Not Used.
- 708 - Existing gutter to remain.
- 709 - Existing gravel guard to remain.
- 710 - .032 aluminum flashing.
- 711 - 3 1/2" fiberglass batt insulation.
- 712 - Membrane flashing.
- 713 - Provide galv. metal extension sleeves to existing scuppers.
- 714 - Sealant.
- 715 - Sealant and backer rod.
- 716 - Caulk.
- 717 - Formed drip.
- 718 - Scored joint.
- 719 - Existing downspout to remain.
- 720 - Existing scuppers to remain.
- 721 - Expansion joint bellows.
- 722 - Strip-in 2'-0" wide single ply membrane roof.
- 723 - PVC control joint.

**DIVISION EIGHT: DOORS AND WINDOWS**

- 801 - Existing store front to remain.
- 802 - Aluminum window.
- 803 - Existing window to remain.
- 804 - Existing door and frame to remain, paint.
- 805 - Aluminum entrance door.
- 806 - 1/4" temp. float glass - clear.
- 807 - 1/4" clear laminate safety glass.
- 808 - 1" insulating bronze glass, tempered.
- 809 - Hollow metal frame.
- 810 - Door, see schedule.
- 811 - Awning type window.
- 812 - Casement type window.
- 813 - Fixed glass window.
- 814 - Alum. Sub-sill.
- 815 - 4" alum. threshold.
- 816 - Alum. door sweeps.
- 817 - Door bottom w/ neoprene gasket.

**DIVISION NINE: FINISHES**

- 901 - 6" x 8" exterior quarry tile, match existing.
- 902 - Align partition with vertical window mullion.
- 903 - In fill opening with typical gypsum board wall construction.
- 904 - 5/8" gypsum board.
- 905 - Existing stucco finish - paint to match new finish.
- 906 - Metal "J" mould.
- 907 - Wood wall paneling - match existing.
- 908 - 5/8" gypsum board on 7/8" resili. furr # 16" O.C.
- 909 - 3 5/8" metal studs # 16" O.C.
- 910 - Reveal moulding, paint black.
- 911 - Existing wall system.
- 912 - 3" mineral fiber batt insulation.
- 913 - Infill opening with salvaged wall system.
- 914 - 2 x 2 suspended acoustical ceiling tile.
- 915 - 8 gauge hanger wire # 2'-0" O.C. - each way.
- 916 - Exterior 5/8" gypsum board sheathings.

**DIVISION FIFTEEN: MECHANICAL**

- 1501 - Handicapped style electric water cooler.
- 1502 - Existing louvers.
- 1503 - Existing exhaust duct.
- 1504 - AC Refrig. lines

**DIVISION SIXTEEN: ELECTRICAL**

- 1601 - Existing conduit.
- 1602 - Existing elec. box.
- 1603 - Existing A/C switch.

- E - Existing, no work
- E-1 - Existing door and frame; sand and paint.
- E-2 - Existing aluminum store front, no work.
- E-3 - Existing window, see detail

CONSULTANTS  
**MECHANICAL:**  
 H. M. YONGE AND ASSOCIATES  
 4227 N. DAVIS HWY., BLDG. A  
 PENSACOLA, FLORIDA 32503  
 (904) 434 - 2661  
**ELECTRICAL:**  
 CORBARI CONSULTING ENGINEERS  
 4227 N. DAVIS HWY., BLDG. A  
 PENSACOLA, FLORIDA 32503  
 (904) 432 - 9523


PROJECT  
**RENOVATIONS TO:**  
**CAREER DEVELOPMENT BUILDING 17**

**CALDWELL ASSOCIATES**  
 ARCHITECTURE  
 PLANNING  
 INTERIOR DESIGN

5401 CORPORATE WOODS DRIVE  
 SUITE 200  
 PENSACOLA, FLORIDA 32504

PROJECT NO. 4589  
 DATE APRIL 5, 1990  
 SHEET TITLE:  
 EXTERIOR ELEVATIONS  
 SHEET 9 OF 27



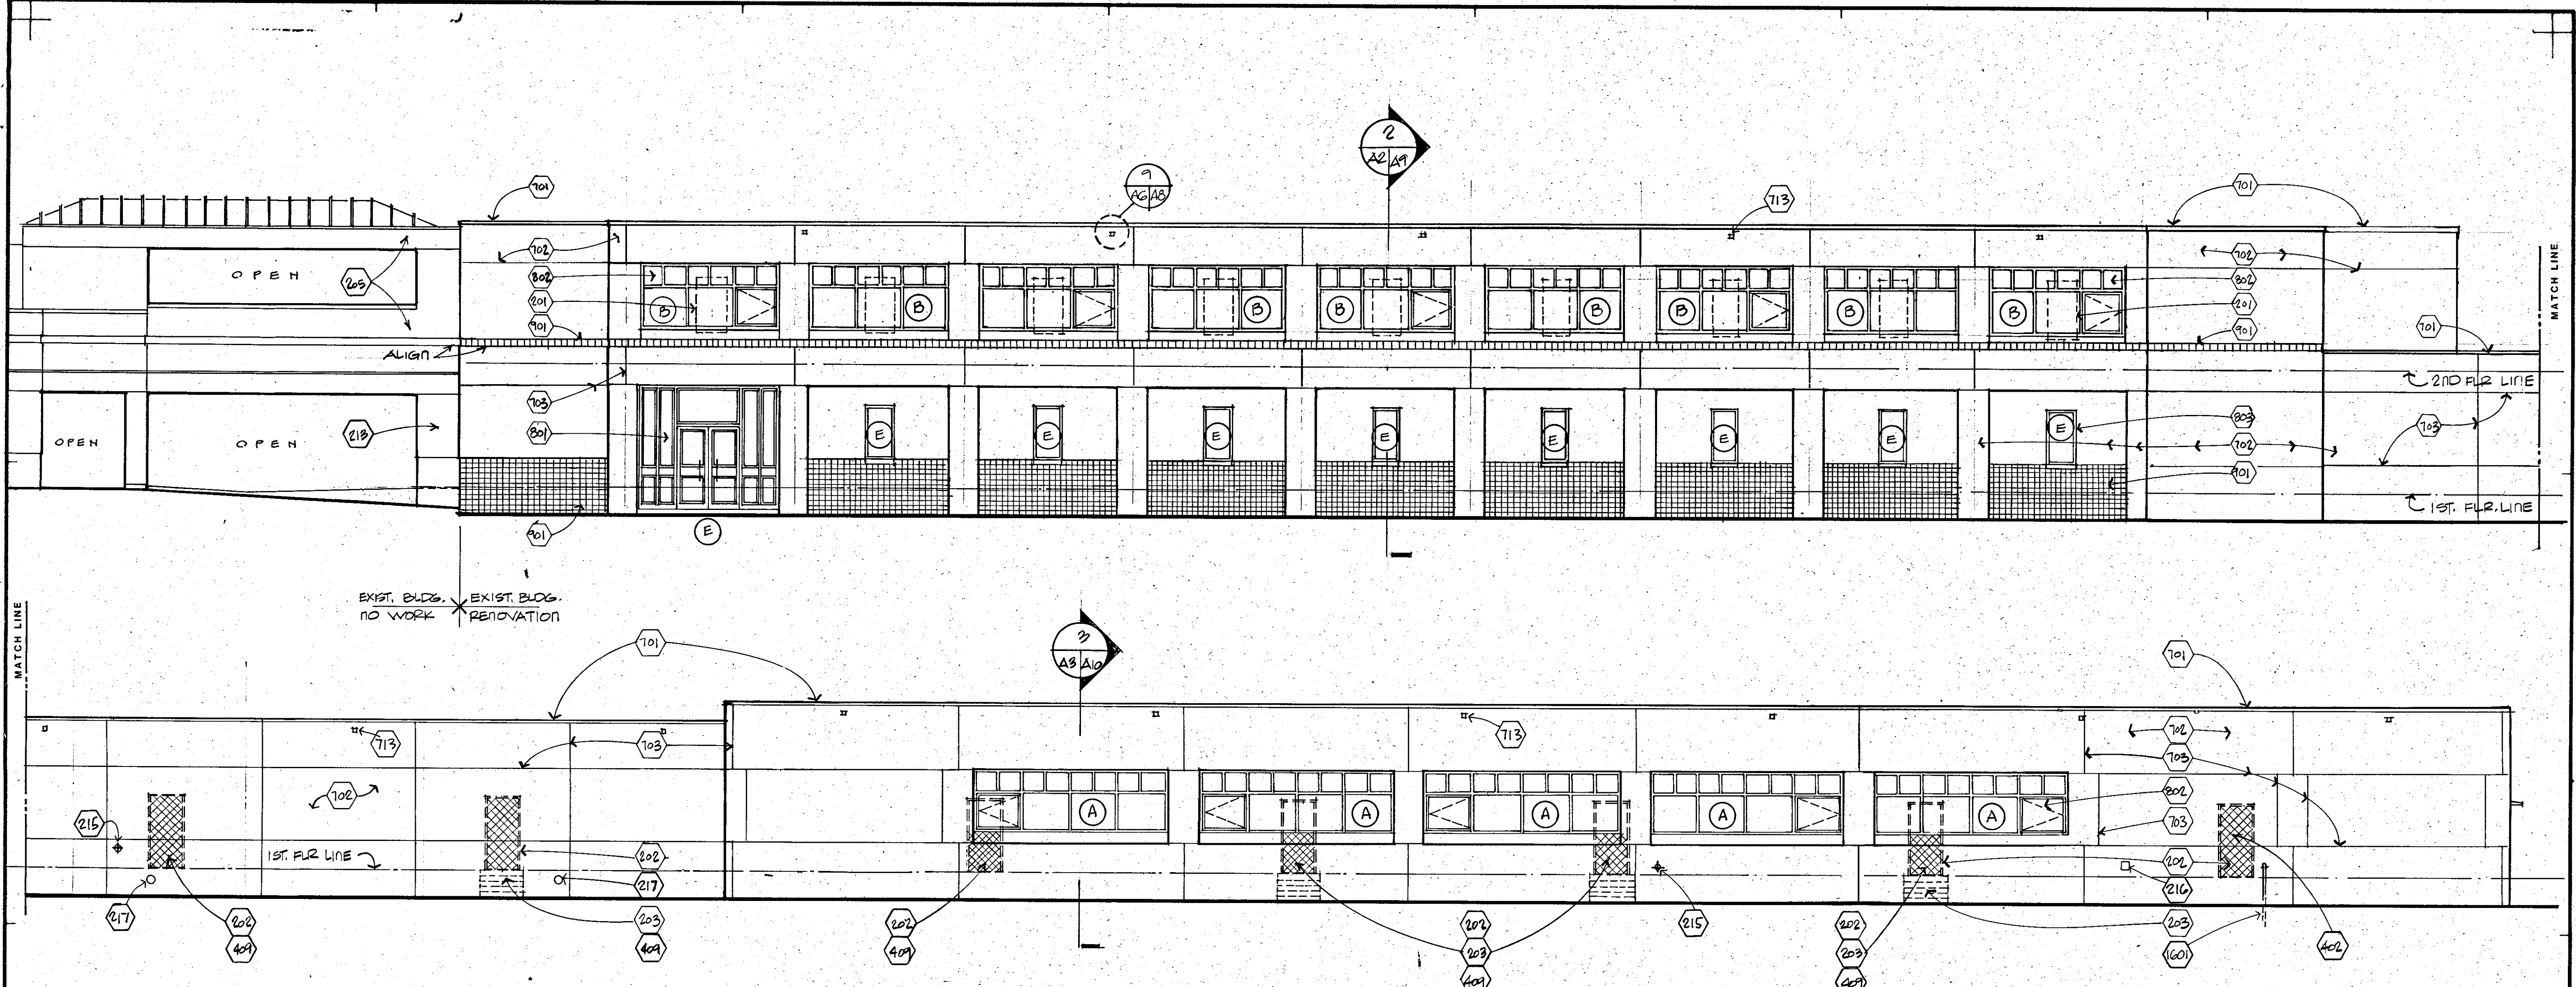


**SOUTH ELEVATION**

SCALE = 1/8" = 1'-0"


**KEYNOTES**

- DIVISION TWO: SITE WORK**
- 201 - Demolish existing window and frame, complete.
  - 202 - Demolish existing door and frame, complete.
  - 203 - Demolish existing concrete steps, complete.
  - 204 - Existing canopy to remain.
  - 205 - Existing walk way to remain, no work.
  - 206 - Demolish existing masonry to receive window.
  - 207 - Demolish existing wall, patch floor and ceiling to receive new finish as indicated.
  - 208 - Demolish existing brick veneer.
  - 209 - Demolish existing exterior canopy.
  - 210 - Demolish existing precast concrete coping.
  - 211 - Demolish existing casework to the extent indicated, patch wall to match existing.
  - 212 - Unless otherwise noted, demolish 5'-0" strip of existing ceiling along exterior wall as shown. Support and protect remaining ceiling as required. Replace with new acoustical tile to match existing.
  - 213 - Existing wing wall to remain. Modify as indicated.
  - 214 - Existing aerial to remain.
  - 215 - Existing hose bibb extend to face of new finish, see mechanical.
  - 216 - Existing wall receptacle. Extend to face of new finish, see electrical.
  - 217 - Existing clean-out to remain, see mechanical.
  - 218 - Demolish plumbing fixtures, cut and cap utilities. Conceal in wall or floor.
  - 219 - Demolish existing wood paneling and wall furring.
  - 220 - Demolish existing masonry to receive door and frame, patch to match existing.
  - 221 - Demolish door, frame to remain, paint.
  - 222 - Existing concrete to remain.
  - 223 - Compacted fill.
  - 224 - Demolish existing quarry tile.
  - 225 - Existing 4" PVC drain to remain.
- DIVISION FOUR: MASONRY**
- 401 - Cast stone sill.
  - 402 - Fill opening with masonry to match, paint.
  - 403 - Existing brick to remain.
  - 404 - Existing concrete masonry units to remain.
  - 405 - Cast stone panels to remain.
  - 406 - Brick to match existing.
  - 407 - Decorative brick to match existing.
  - 408 - Masonry anchors # 24" O.C.
  - 409 - Infill opening below new window with masonry to match, paint.
  - 410 - 8" U block, cut down as required.
- DIVISION SEVEN: THERMAL AND MOISTURE PROTECTION**
- 701 - Prefabricated aluminum coping.
  - 702 - Exterior insulation and finish system.
  - 703 - Control joint, see detail 5/A5.
  - 704 - 0.032" Aluminum counter flashing.
  - 705 - Not Used.
  - 706 - Form roof to remain.
  - 707 - Not Used.
  - 708 - Existing gutter to remain.
  - 709 - Existing gravel guard to remain.
  - 710 - .032" aluminum flashing.
  - 711 - 3 1/2" fiberglass batt insulation.
  - 712 - Membrane flashing.
  - 713 - Provide galv. metal extension sleeves to existing scuppers.
  - 714 - Sealant.
  - 715 - Sealant and backer rod.
  - 716 - Caulk.
  - 717 - Formed drip.
  - 718 - Scored joint.
  - 719 - Existing downspout to remain.
  - 720 - Existing scupper to remain.
  - 721 - Expansion joint bellows.
  - 722 - Strip-in 2"-0" wide single ply membrane roof.
  - 723 - PVC control joint.
- DIVISION EIGHT: DOORS AND WINDOWS**
- 801 - Existing store front to remain.
  - 802 - Aluminum window.
  - 803 - Existing window to remain.
  - 804 - Existing door and frame to remain, paint.
  - 805 - Aluminum entrance door.
  - 806 - 1/4" temp. float glass - clear.
  - 807 - 1/4" clear laminated safety glass.
  - 808 - 1" insulating bronze glass, tempered.
  - 809 - Hollow metal frame.
  - 810 - Door, see schedule.
  - 811 - Awning - type window.
  - 812 - Casement - type window.
  - 813 - Fixed glass window.
  - 814 - Alum. Sub-sill.
  - 815 - Alum. threshold.
  - 816 - Alum. door sweep.
  - 817 - Door bottom w/ neoprene gasket.
- DIVISION NINE: FINISHES**
- 901 - 8" X 8" exterior quarry tile, match existing.
  - 902 - Align partition with vertical window mullion.
  - 903 - In fill opening with typical gypsum board wall construction.
  - 904 - 5/8" gypsum board.
  - 905 - Existing stucco finish - paint to match new finish.
  - 906 - Metal "J" mould.
  - 907 - Wood wall paneling - match existing.
  - 908 - 5/8" gypsum board on 7/8" resill. furr # 16" O.C.
  - 909 - 3 5/8" metal studs # 16" O.C.
  - 910 - Reveal molding, paint black.
  - 911 - Existing wall system.
  - 912 - 3" mineral fiber batt insulation.
  - 913 - Infill opening with salvaged well system.
  - 914 - 2 X 2 suspended acoustical ceiling tile.
  - 915 - 9 gauge hanger wire # 2'-0" O.C., each way.
  - 916 - Exterior 5/8" gypsum board sheathing.
- DIVISION SIXTEEN: ELECTRICAL**
- 1601 - Existing conduit.
  - 1602 - Existing elec. box.
  - 1603 - Existing A/C switch.
- EXISTING, NO WORK**
- E - Existing, no work
  - E-1 - Existing door and frame; sand and paint.
  - E-2 - Existing aluminum store front, no work.
  - E-3 - Existing window, see detail.

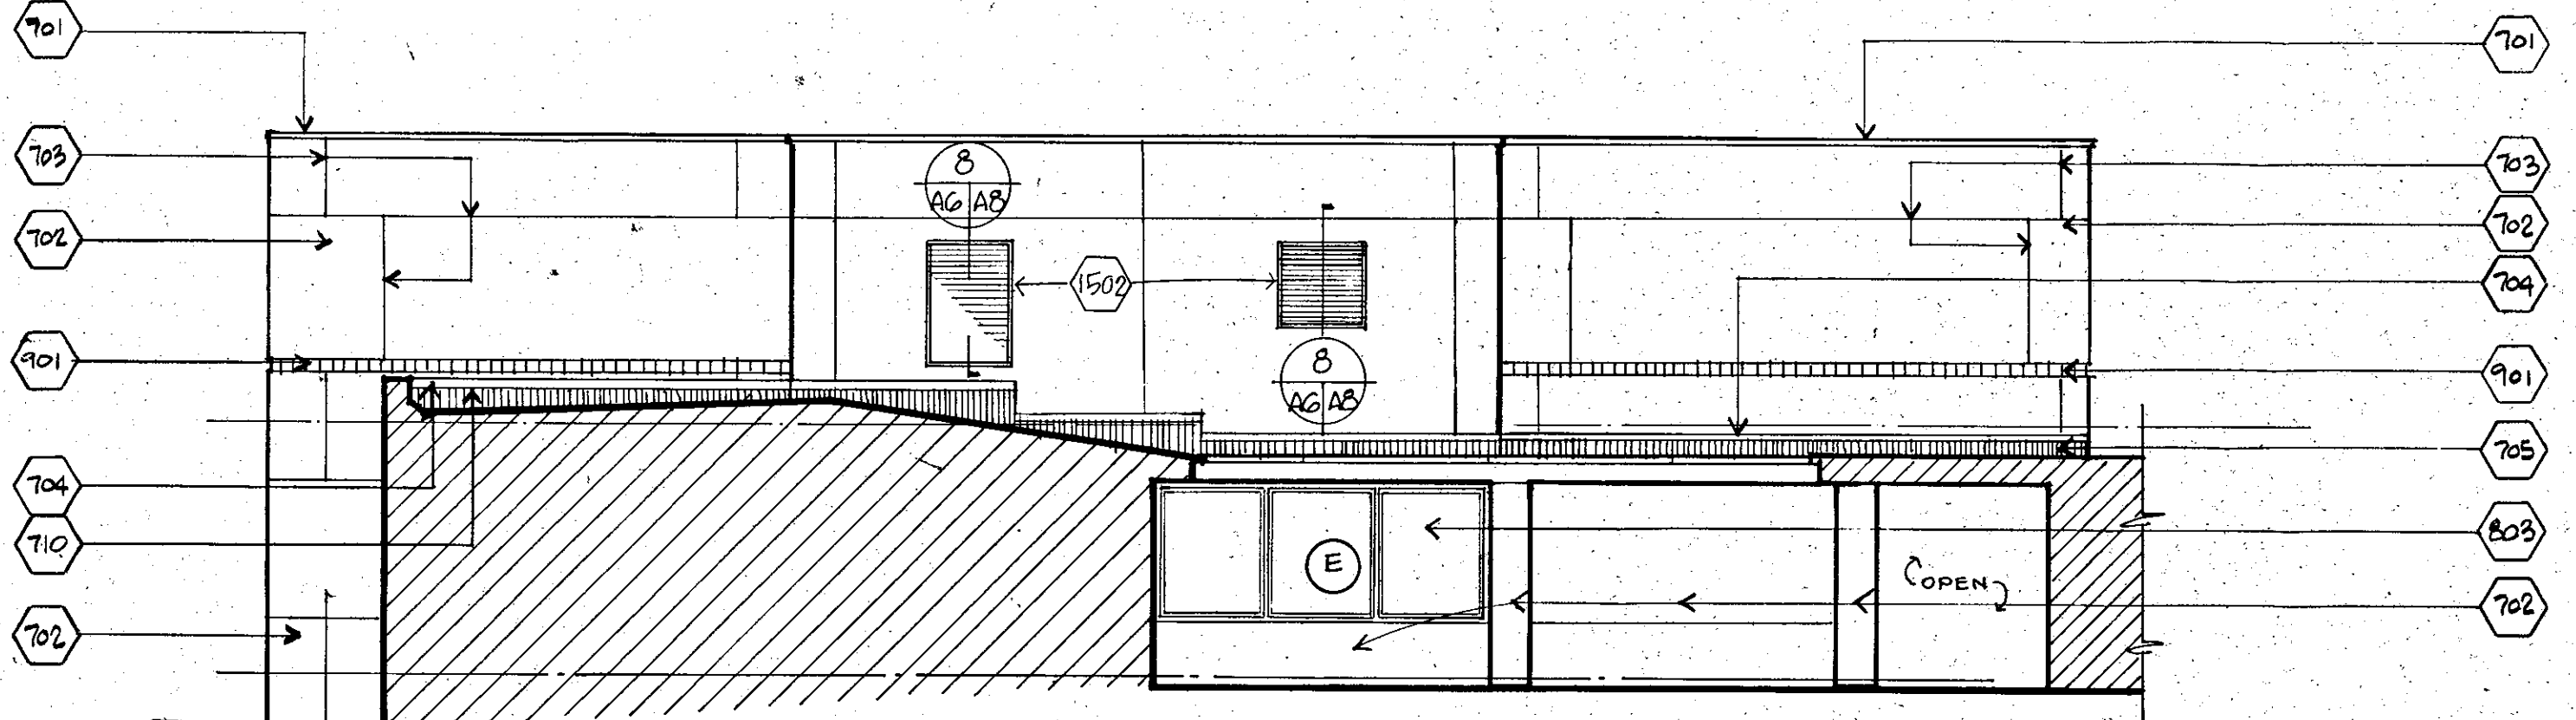


**PARTIAL EAST ELEVATION**

SCALE = 1/8" = 1'-0"

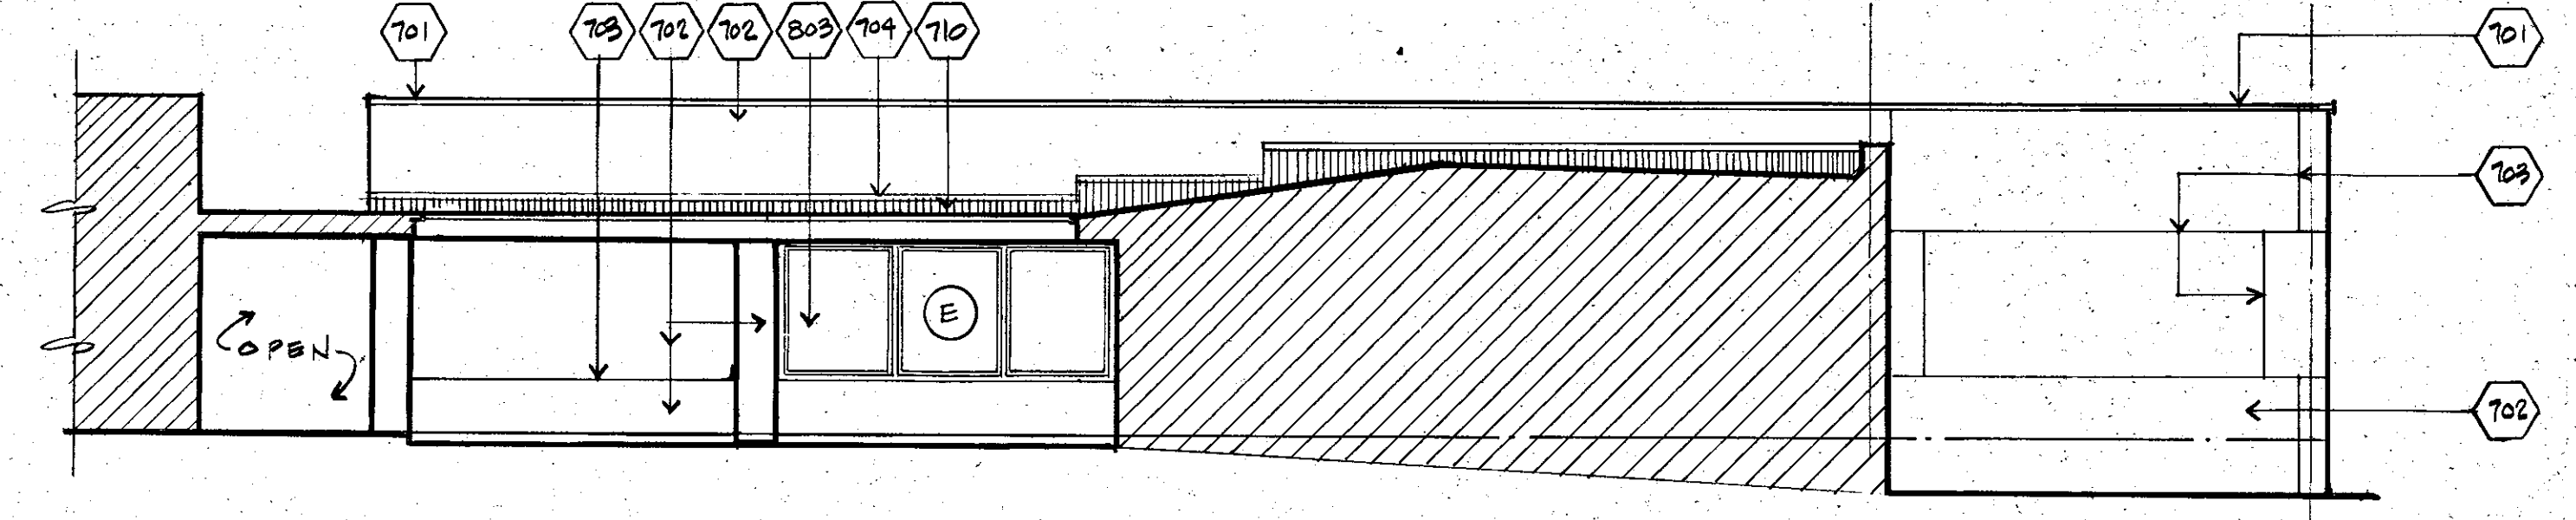

**PARTIAL WEST ELEVATION**

SCALE = 1/8" = 1'-0"

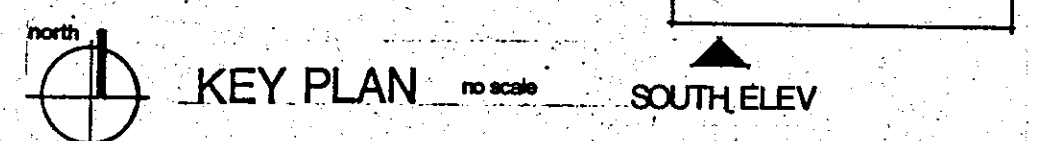

**CONSULTANTS**

- MECHANICAL:**  
 H. M. YONGE AND ASSOCIATES  
 4227 N. DAVIS HWY., BLDG. A  
 PENSACOLA, FLORIDA 32503  
 (904) 434 - 2661
- ELECTRICAL:**  
 CORBARI CONSULTING ENGINEERS  
 4227 N. DAVIS HWY., BLDG. A  
 PENSACOLA, FLORIDA 32503  
 (904) 432 - 9523

**PROJECT**

RENOVATIONS TO:  
  
**CAREER DEVELOPMENT BUILDING 17**


**CALDWELL ASSOCIATES**

ARCHITECTURE  
 PLANNING  
 INTERIOR DESIGN


5401 CORPORATE WOODS DRIVE  
 SUITE 200  
 PENSACOLA, FLORIDA 32504

PROJECT NO: 4589  
 DATE: APRIL 5, 1990  
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 EXTERIOR ELEVATIONS  
 SHEET 8 OF 27




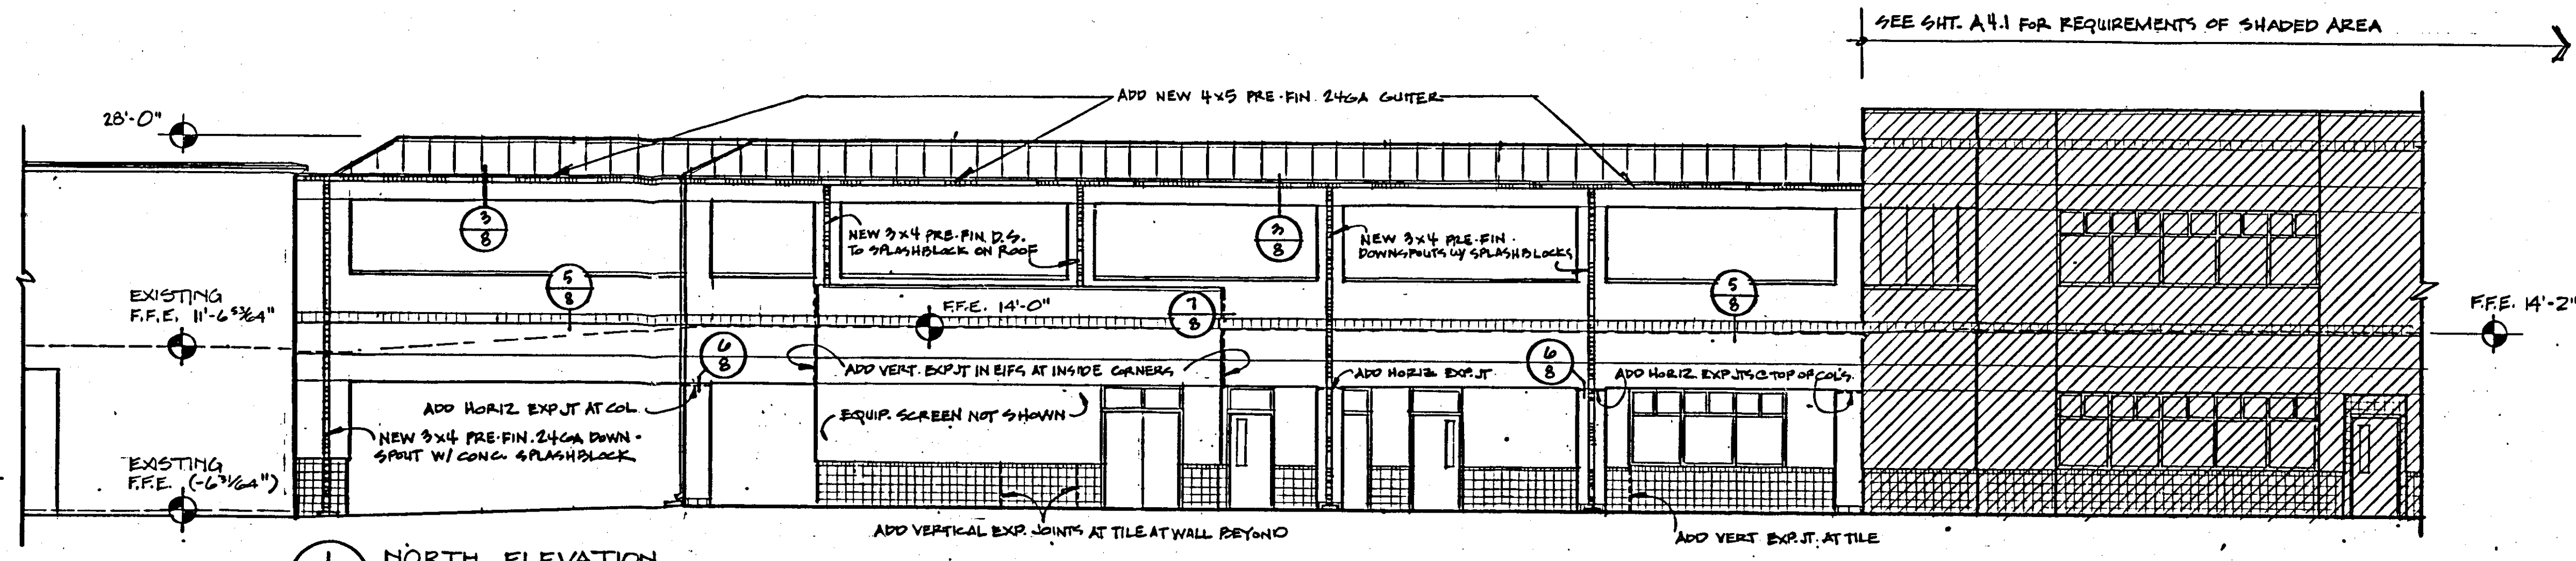


1 NORTH ELEVATION  
 A18.3 SCALE: 1/8"=1'-0"

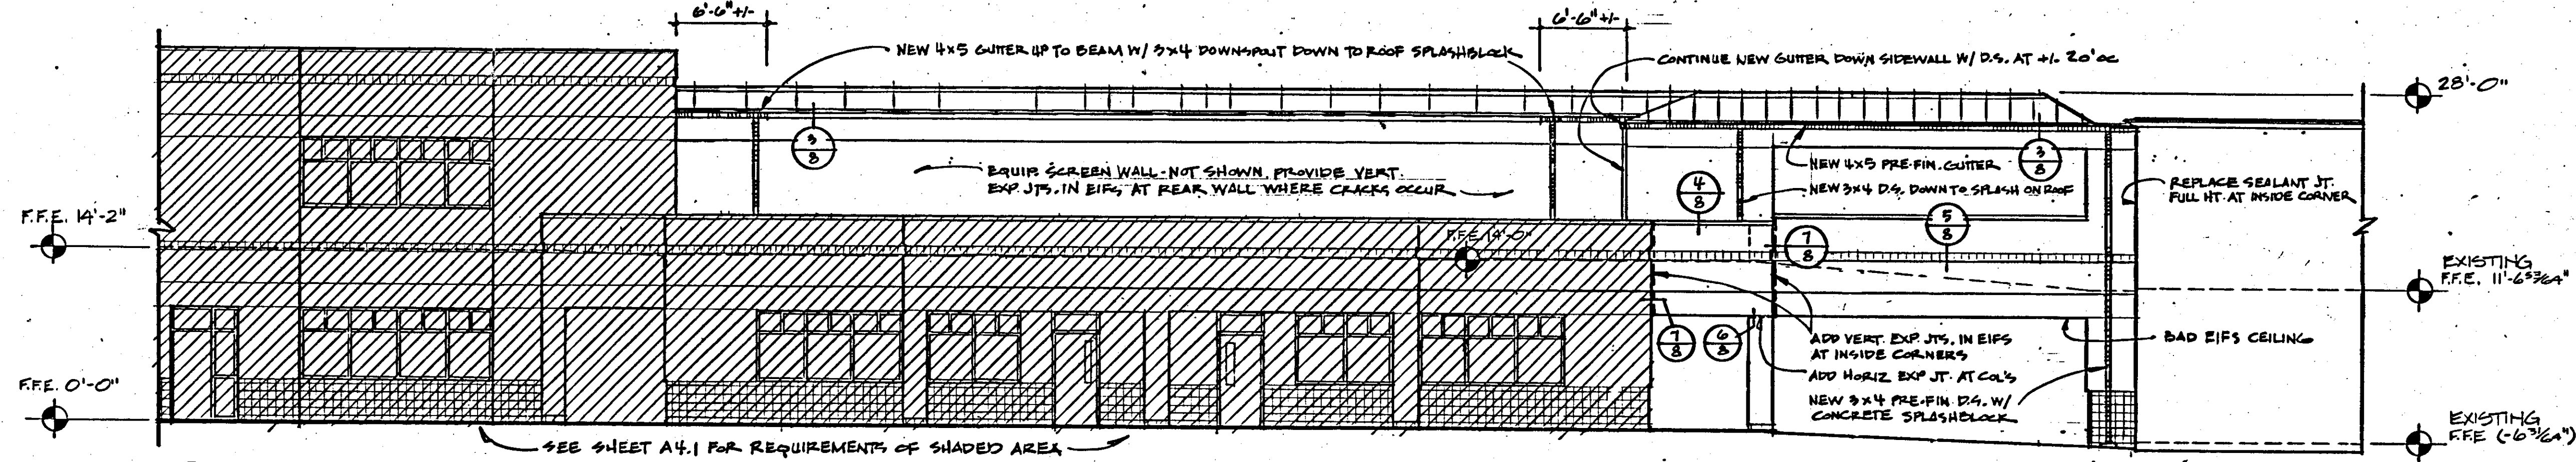

2 SOUTH ELEVATION  
 A18.3 SCALE: 1/8"=1'-0"

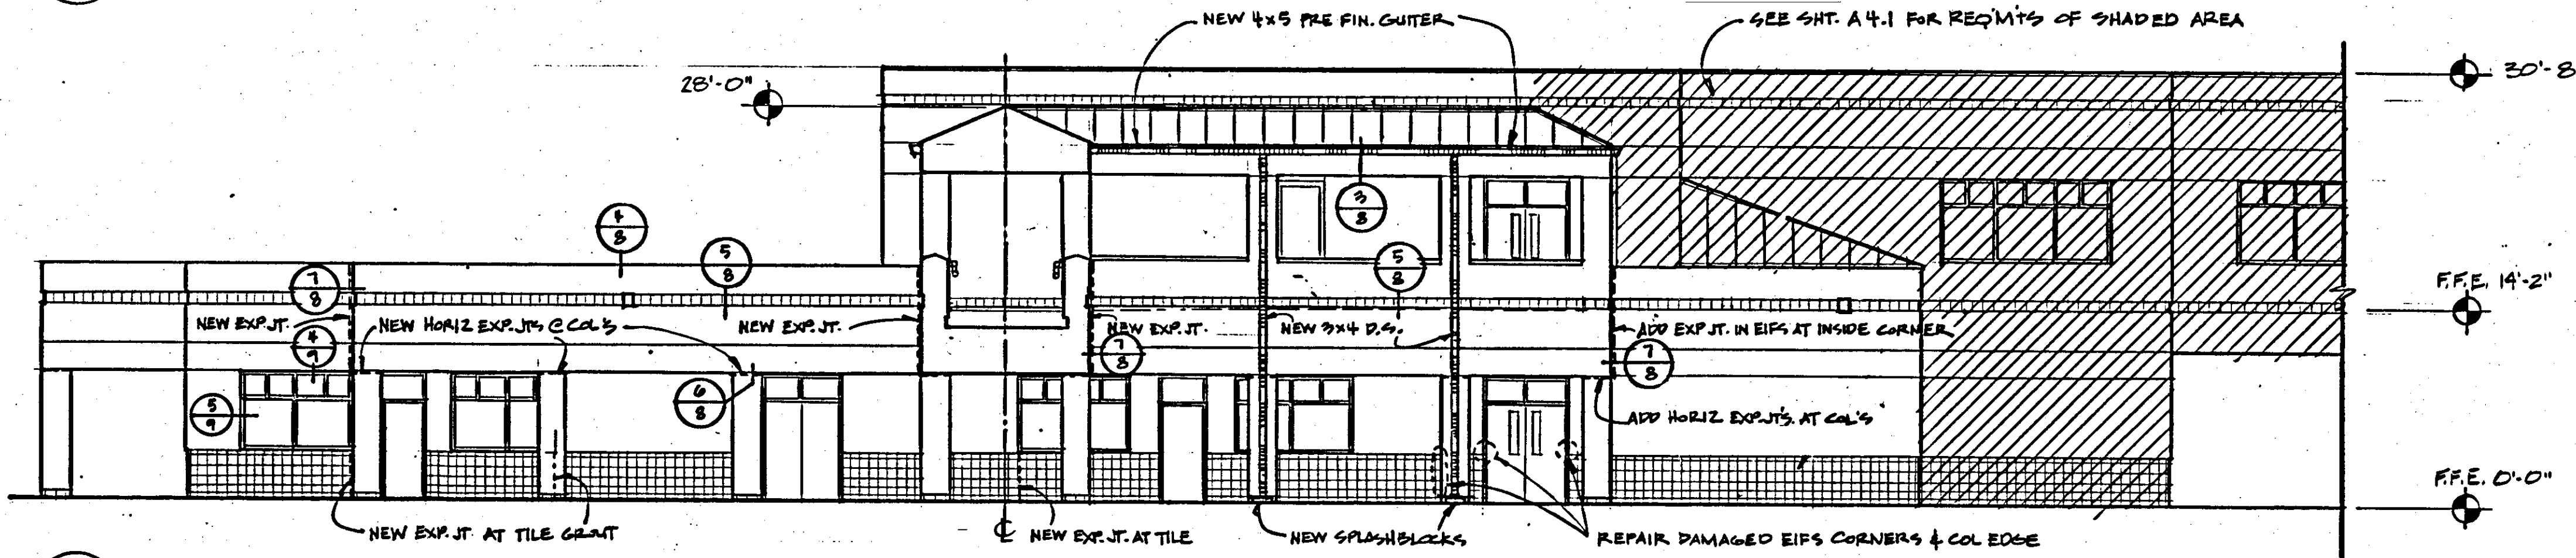

3 EAST ELEVATION  
 A18.3 SCALE: 1/8"=1'-0"

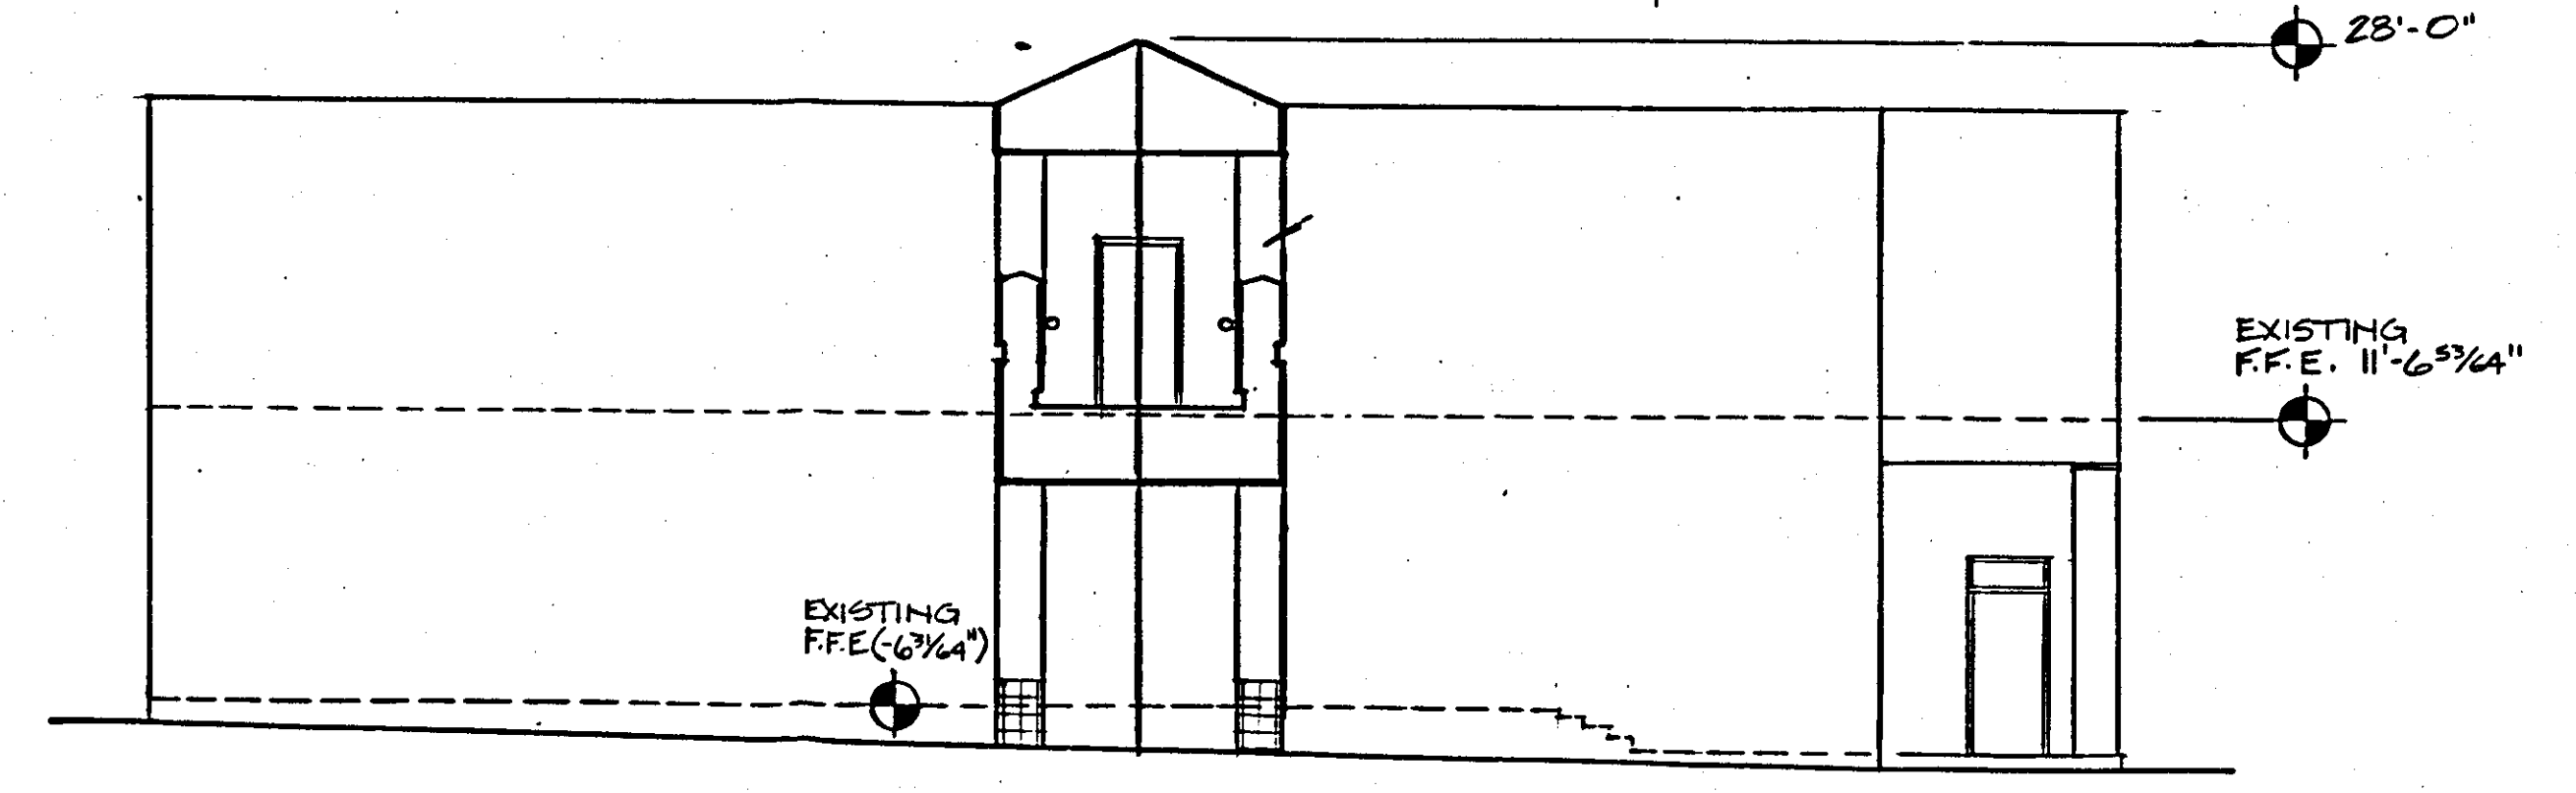

4 WEST ELEVATION OF BLDG 17  
 A18.3 SCALE: 1/8"=1'-0"

**Final Repair Drawings**  
 issued: 4/18/1997

- 1 - GROUND FLOOR PLAN - SOUTHEAST WING
- 2 - GROUND FLOOR PLAN - NORTHWEST WING
- 3 - PEDESTRIAN BRIDGE PLAN
- 4 - BUILDING ELEVATIONS - SOUTHEAST WING
- 5 - BUILDING ELEVATIONS - NORTHWEST WING
- 6 - PEDESTRIAN BRIDGE ELEVATIONS
- 7 - EXHAUST STACK ENCLOSURES
- 8 - DETAILS
- 9 - DETAILS

PROJECT

NEW CENTER OF  
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 ENGINEERING &  
 TECHNOLOGY

PENSACOLA  
 JUNIOR  
 COLLEGE

BULLOCK • TICE ASSOCIATES  
 ARCHITECTS  
 INC


900 EAST  
 CRAWFORD SUITE B  
 PENSACOLA, FLORIDA 32501  
 904-434-5444  
 FAX 904-432-5208

ARCHITECTURE  
 PLANNING  
 INTERIOR DESIGN


DRAWN BY:  
 CHECKED BY:  
 APPROVED BY:  
 PROJECT NO: 63788.01  
 DATE: MARCH 21, 1989  
 SHEET TITLE:  
 PEDESTRIAN BRIDGE AND WALKWAY  
 ELEVATIONS

SHEET OF

NOTE:  
 THE PEDESTRIAN BRIDGE & WALKWAY AS SHOWN ON THIS  
 SHEET ARE PART OF ALTERNATE #2.

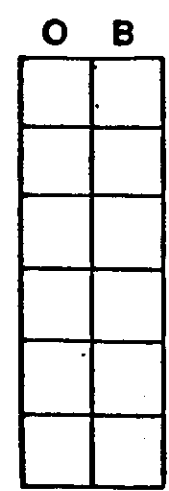



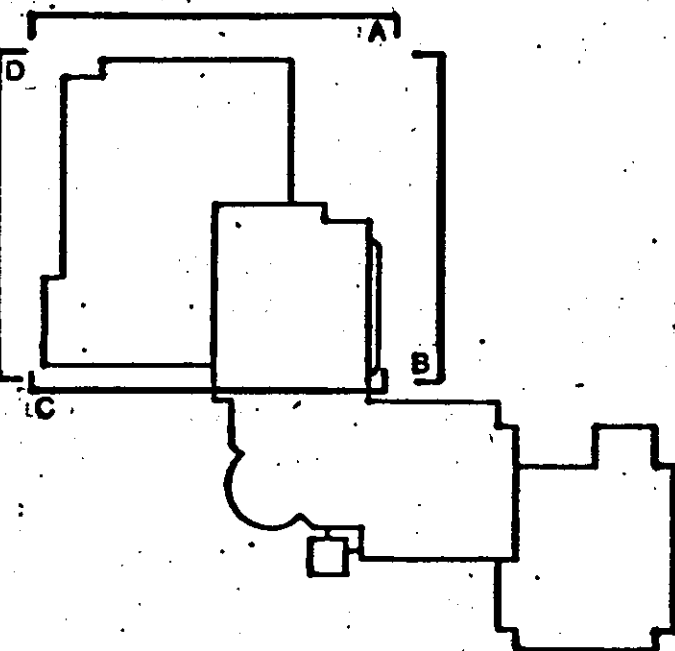

**Final Repair Drawings**  
 issued: 4/18/1997

- 1 - GROUND FLOOR PLAN - SOUTHWEST WING
- 2 - GROUND FLOOR PLAN - NORTHWEST WING
- 3 - PEDESTRIAN BRIDGE PLAN
- 4 - BUILDING ELEVATIONS - SOUTHWEST WING
- 5 - BUILDING ELEVATIONS - NORTHWEST WING
- 6 - PEDESTRIAN BRIDGE ELEVATIONS
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 & ASSOCIATES  
 INC.**

909 EAST  
 CERAMIKS SUITE B  
 PENSACOLA, FLORIDA 32501  
 904-434-5444

1110  
 MONTLUMAR  
 DRIVE, SUITE 540  
 MOBILE, ALABAMA 36607  
 205-343-2852

ARCHITECTURE  
 PLANNING  
 INTERIOR DESIGN  
 CONSTRUCTION MANAGEMENT


PROJECT NO. 63788.01

DATE MARCH 21, 1989


SHEET TITLE

BUILDING ELEVATIONS -  
 NORTHWEST WING


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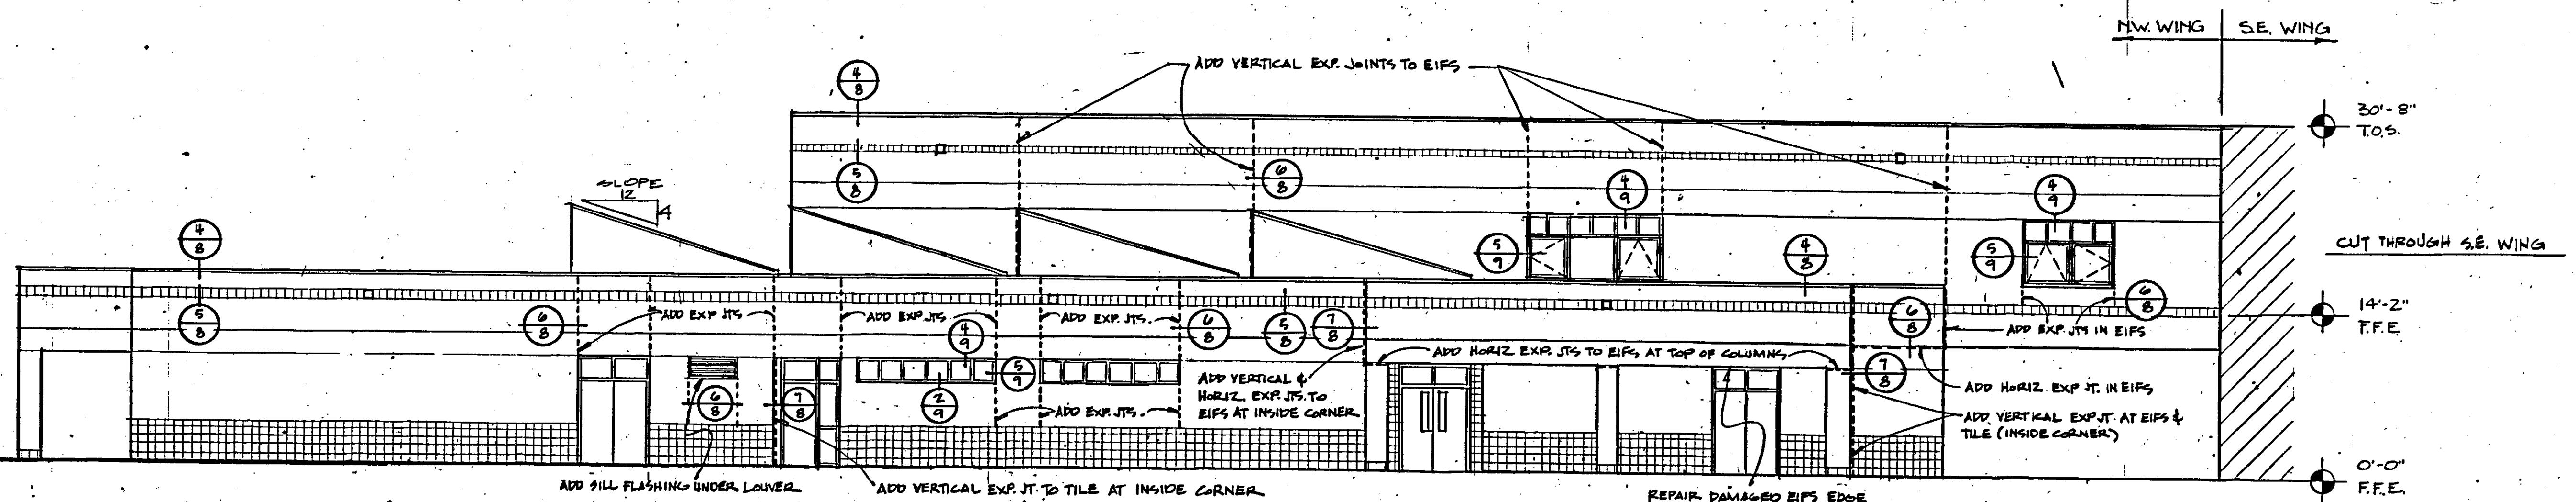
**(A) NORTH ELEVATION**  
 A4.2 SCALE: 1/8" = 1'-0"

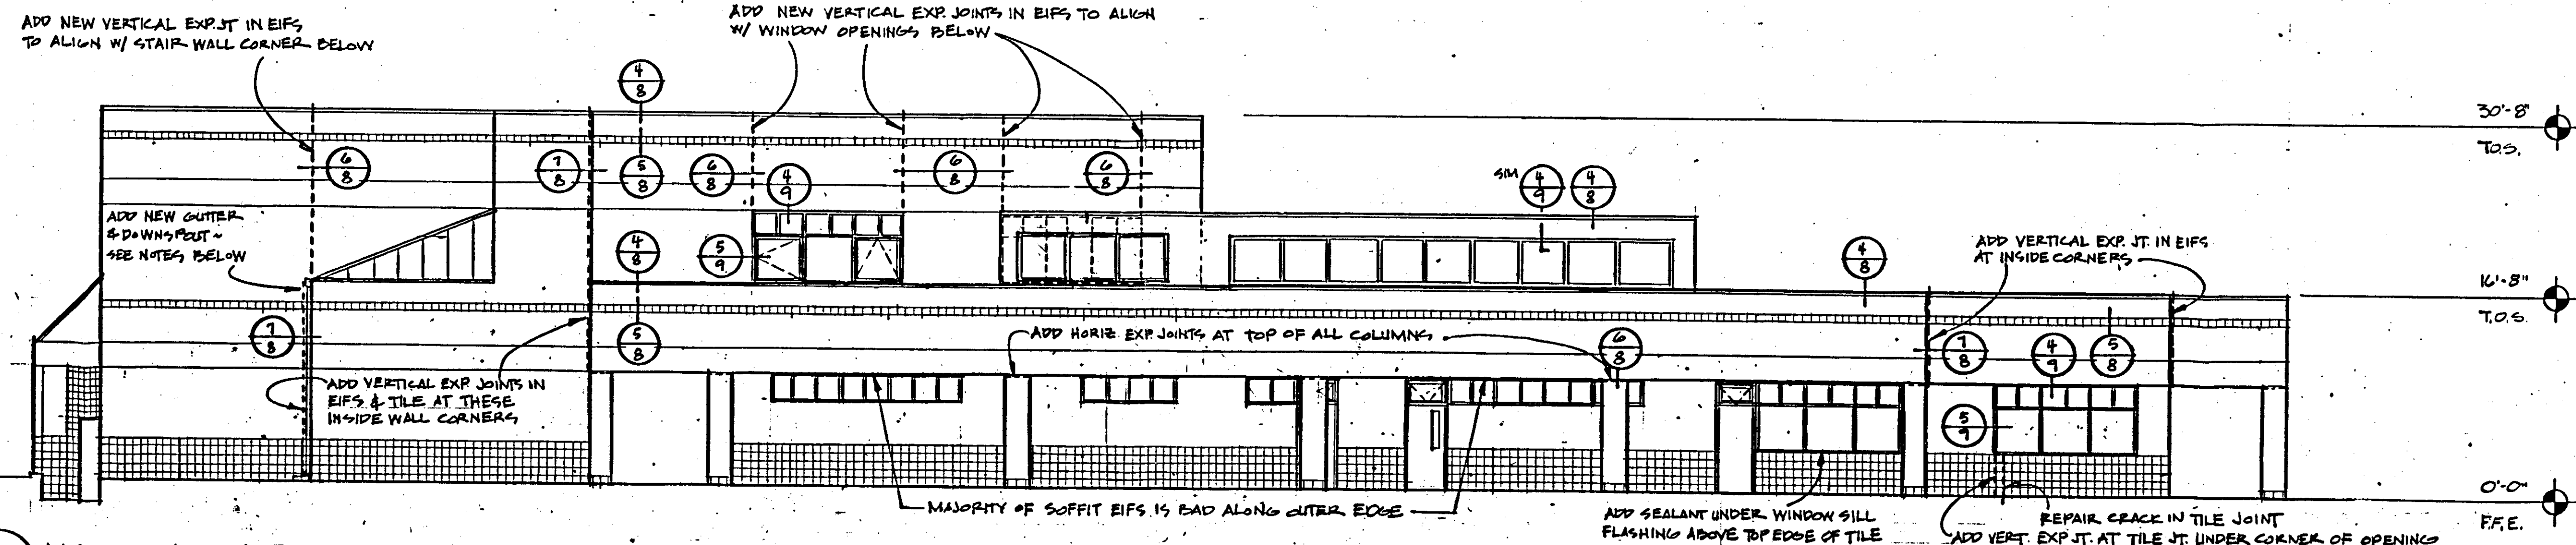

**(B) EAST ELEVATION**  
 A4.2 SCALE: 1/8" = 1'-0"

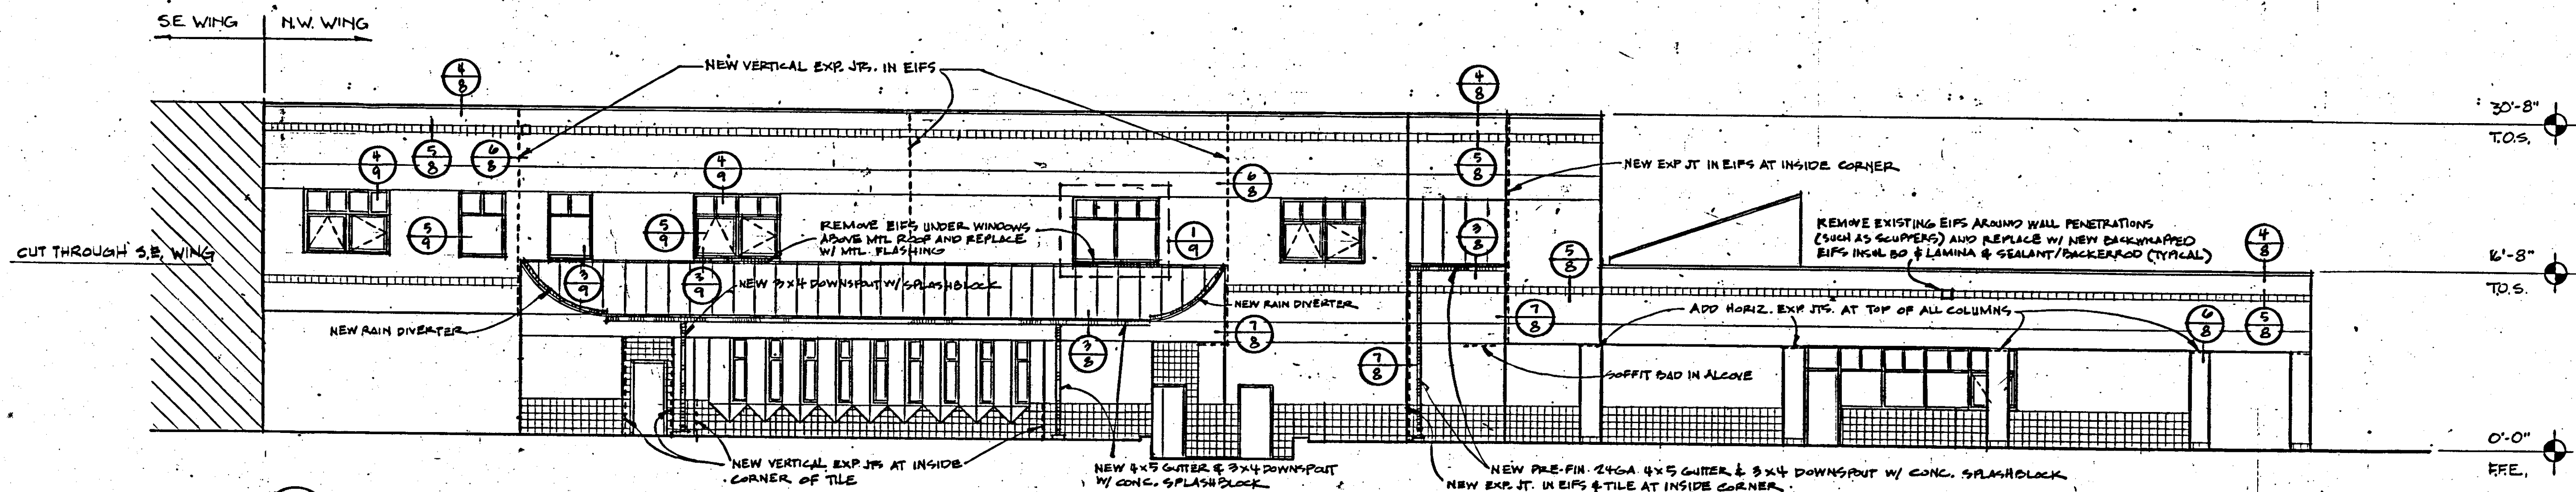


**(C) SOUTH ELEVATION**  
 A4.2 SCALE: 1/8" = 1'-0"

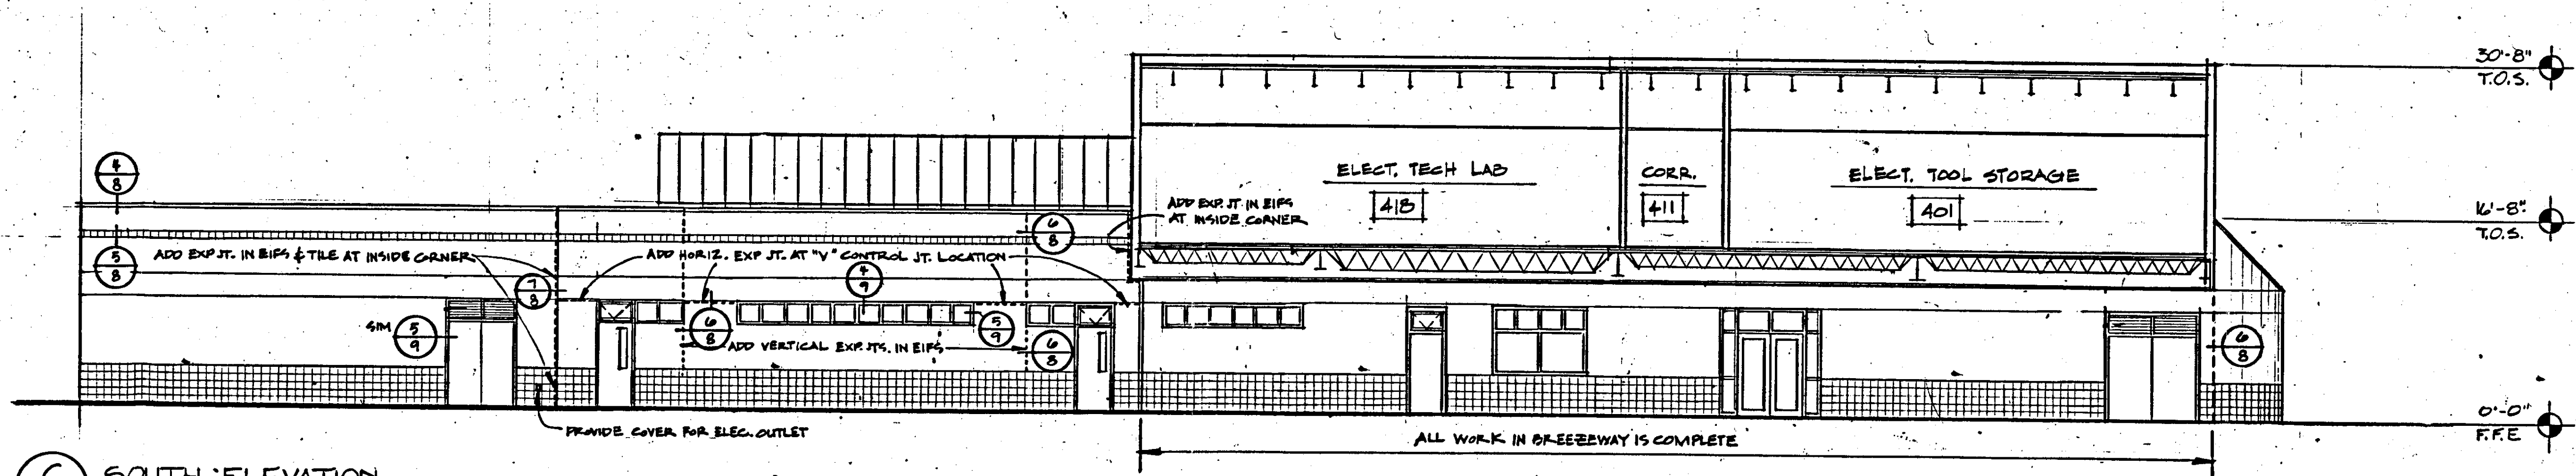


**(D) WEST ELEVATION**  
 A4.2 SCALE: 1/8" = 1'-0"






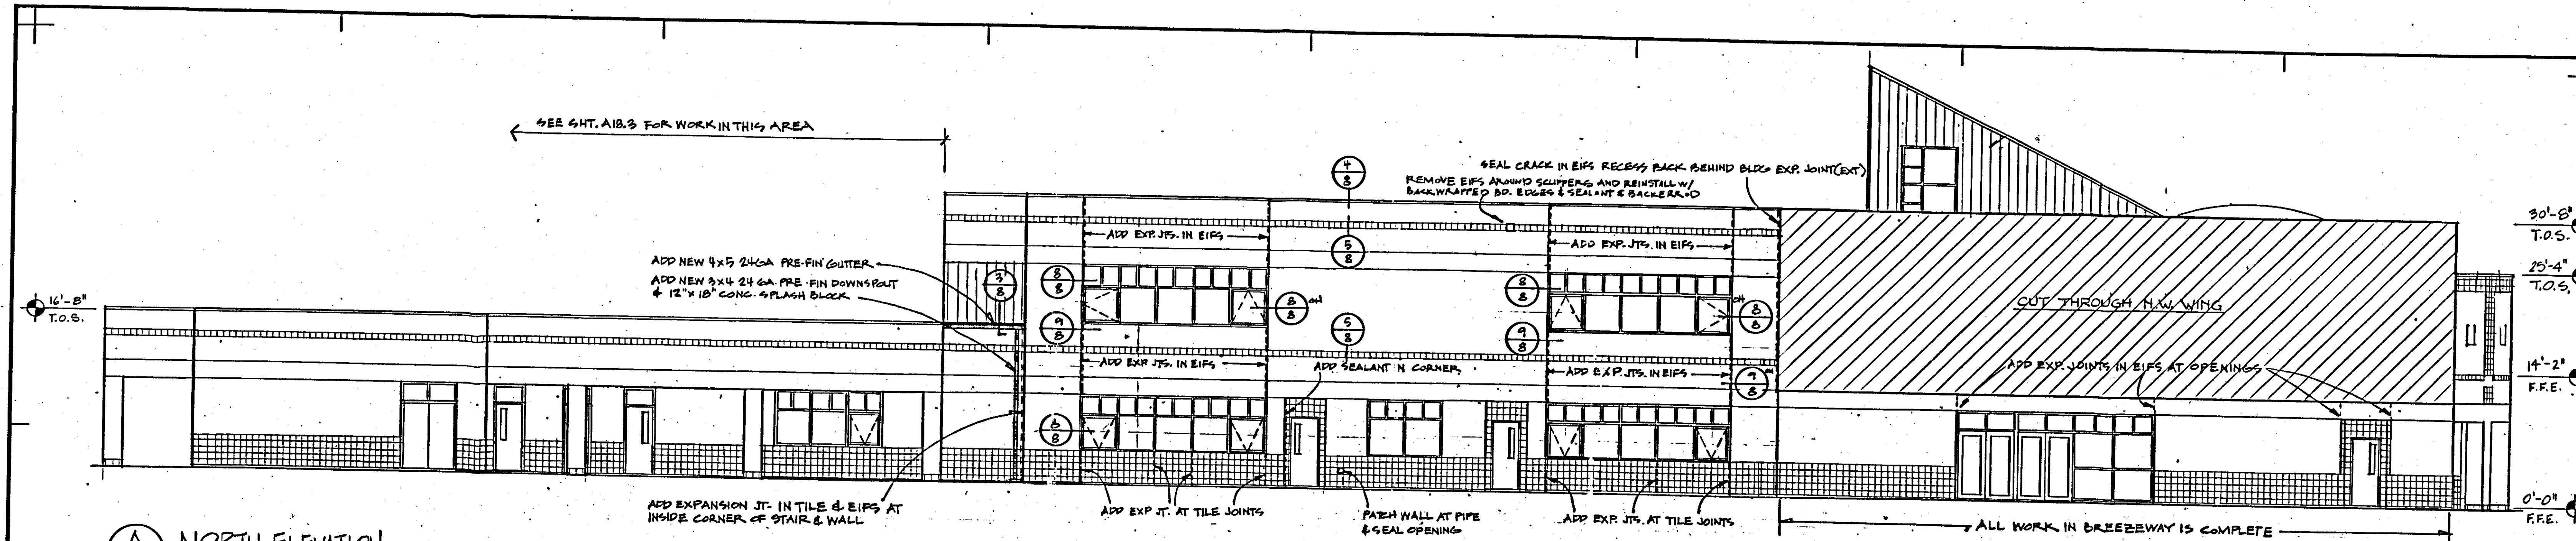


**A NORTH ELEVATION**  
 A4.1 SCALE: 1/8" = 1'-0"

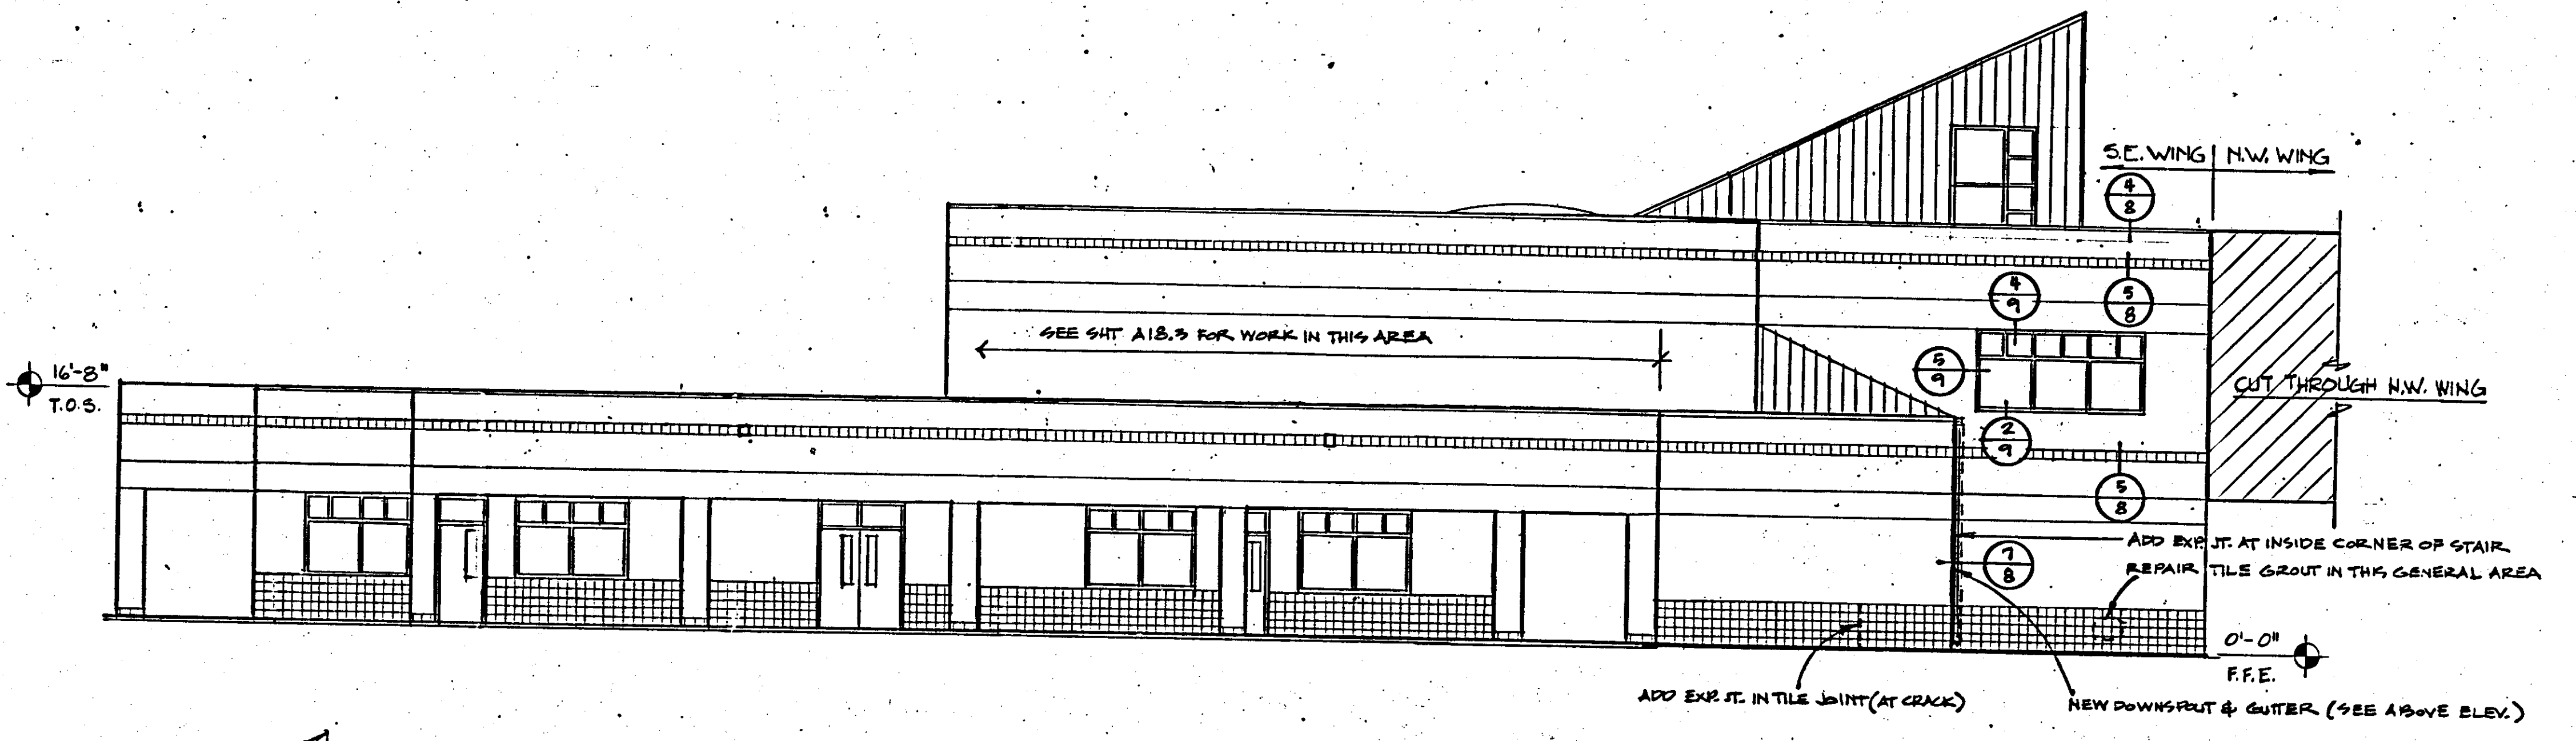


**B EAST ELEVATION**  
 A4.1 SCALE: 1/8" = 1'-0"

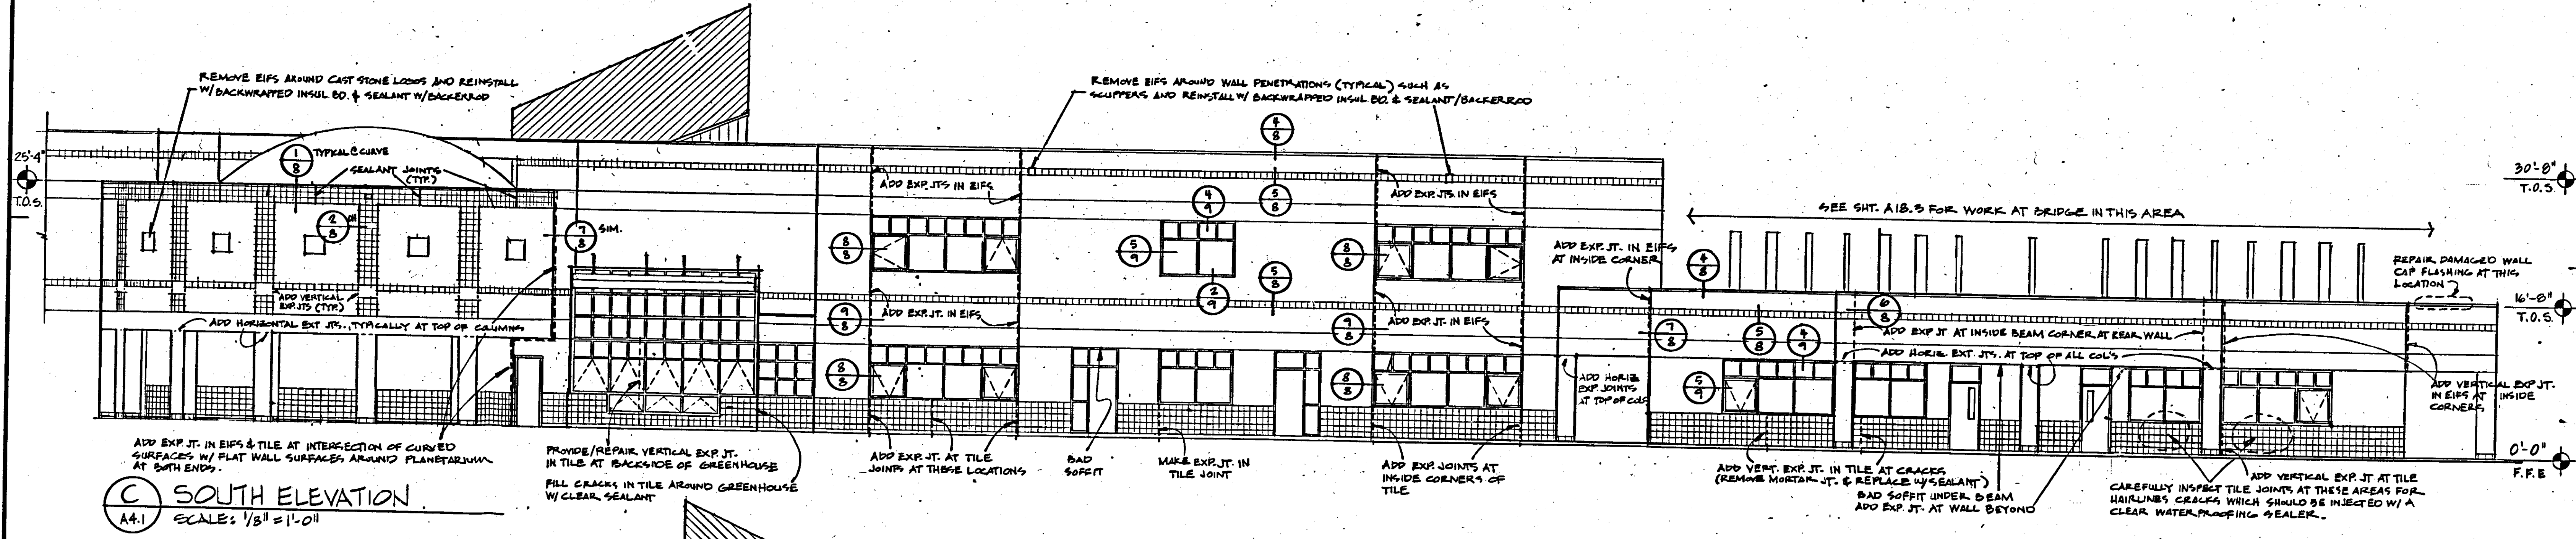

**C SOUTH ELEVATION**  
 A4.1 SCALE: 1/8" = 1'-0"

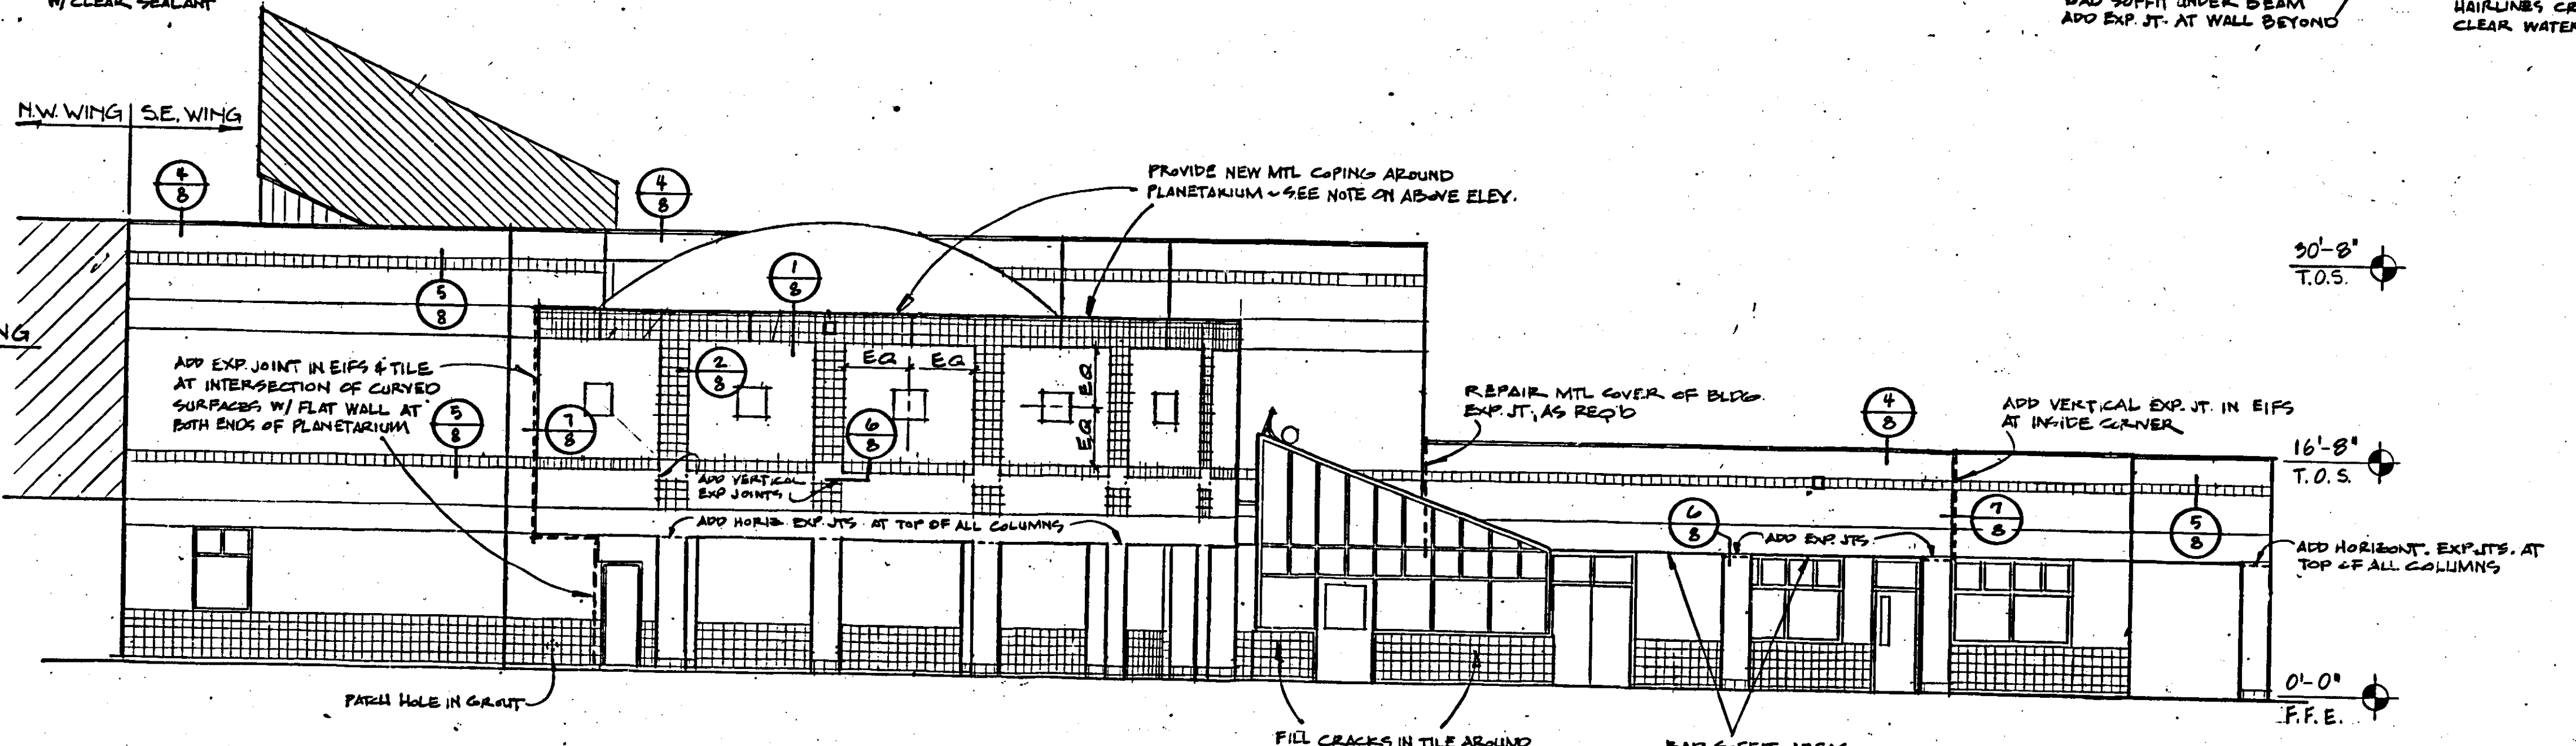

**D WEST ELEVATION**  
 A4.1 SCALE: 1/8" = 1'-0"

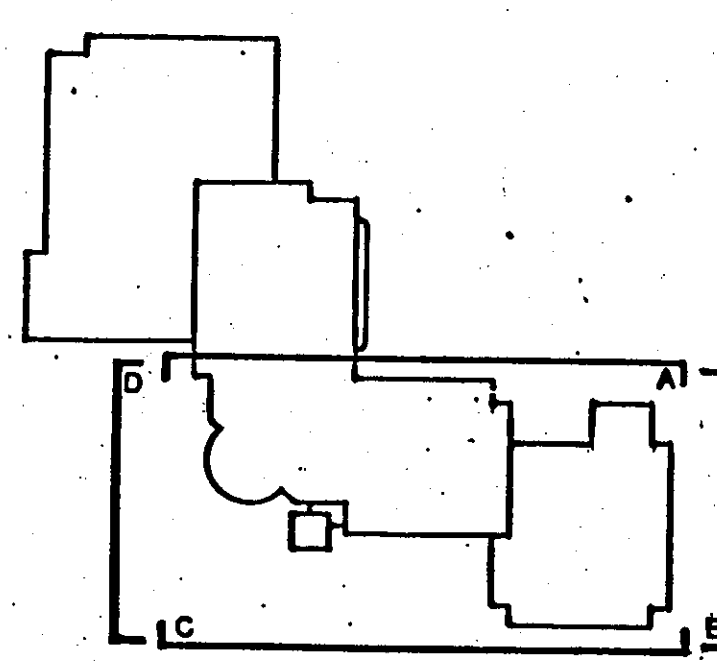

- Final Repair Drawings**  
 issued: 4/18/1997
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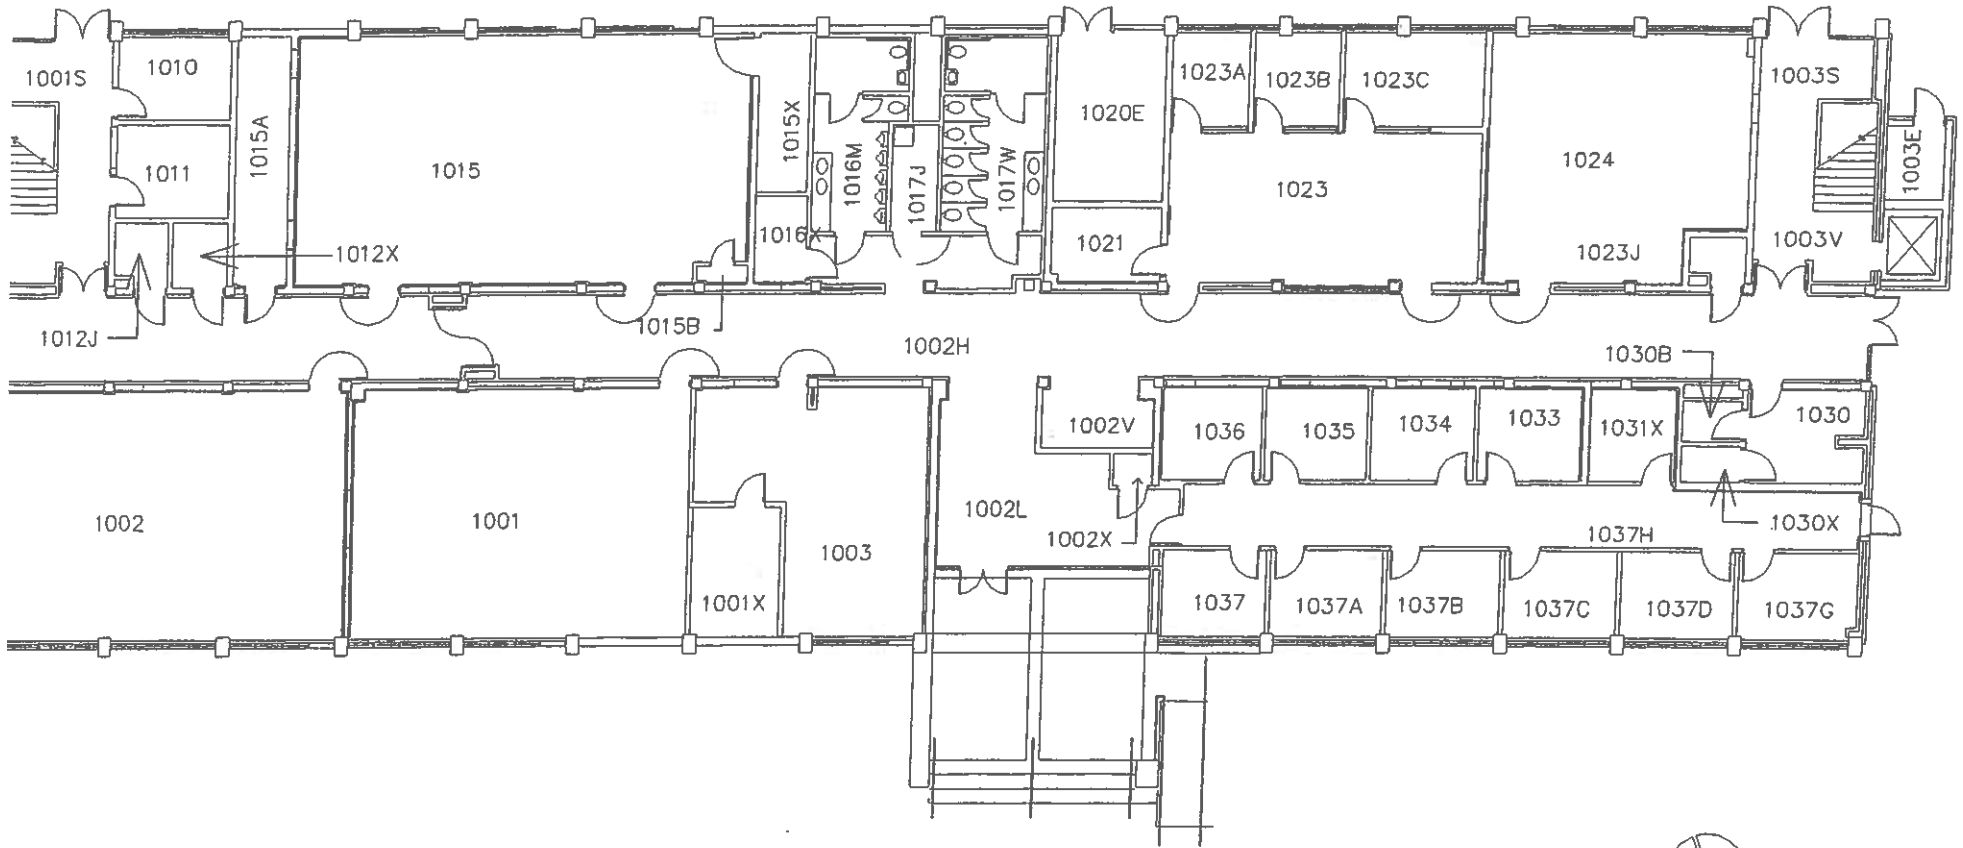
909 EAST  
 CERAMITES SUITE B  
 PENSACOLA, FLORIDA 32501  
 904-434-5444

1110  
 MCINTLISHAR  
 DRIVE, SUITE 540  
 MOBILE, ALABAMA 36609  
 205-343-2852

ARCHITECTURE  
 PLANNING  
 INTERIOR DESIGN  
 CONSTRUCTION MANAGEMENT

PROJECT NO. 63788.01  
 DATE MARCH 21, 1989  
 SHEET TITLE  
 BUILDING ELEVATIONS,  
 SOUTHEAST WING  
 SHEET OF


ATTACHMENT B



PENSACOLA JUNIOR COLLEGE  
PENSACOLA CAMPUS  
SITE NO. 1  
FACILITY NO. 10  
FACILITY NAME: BUSINESS EDUCATION  
FIRST FLOOR






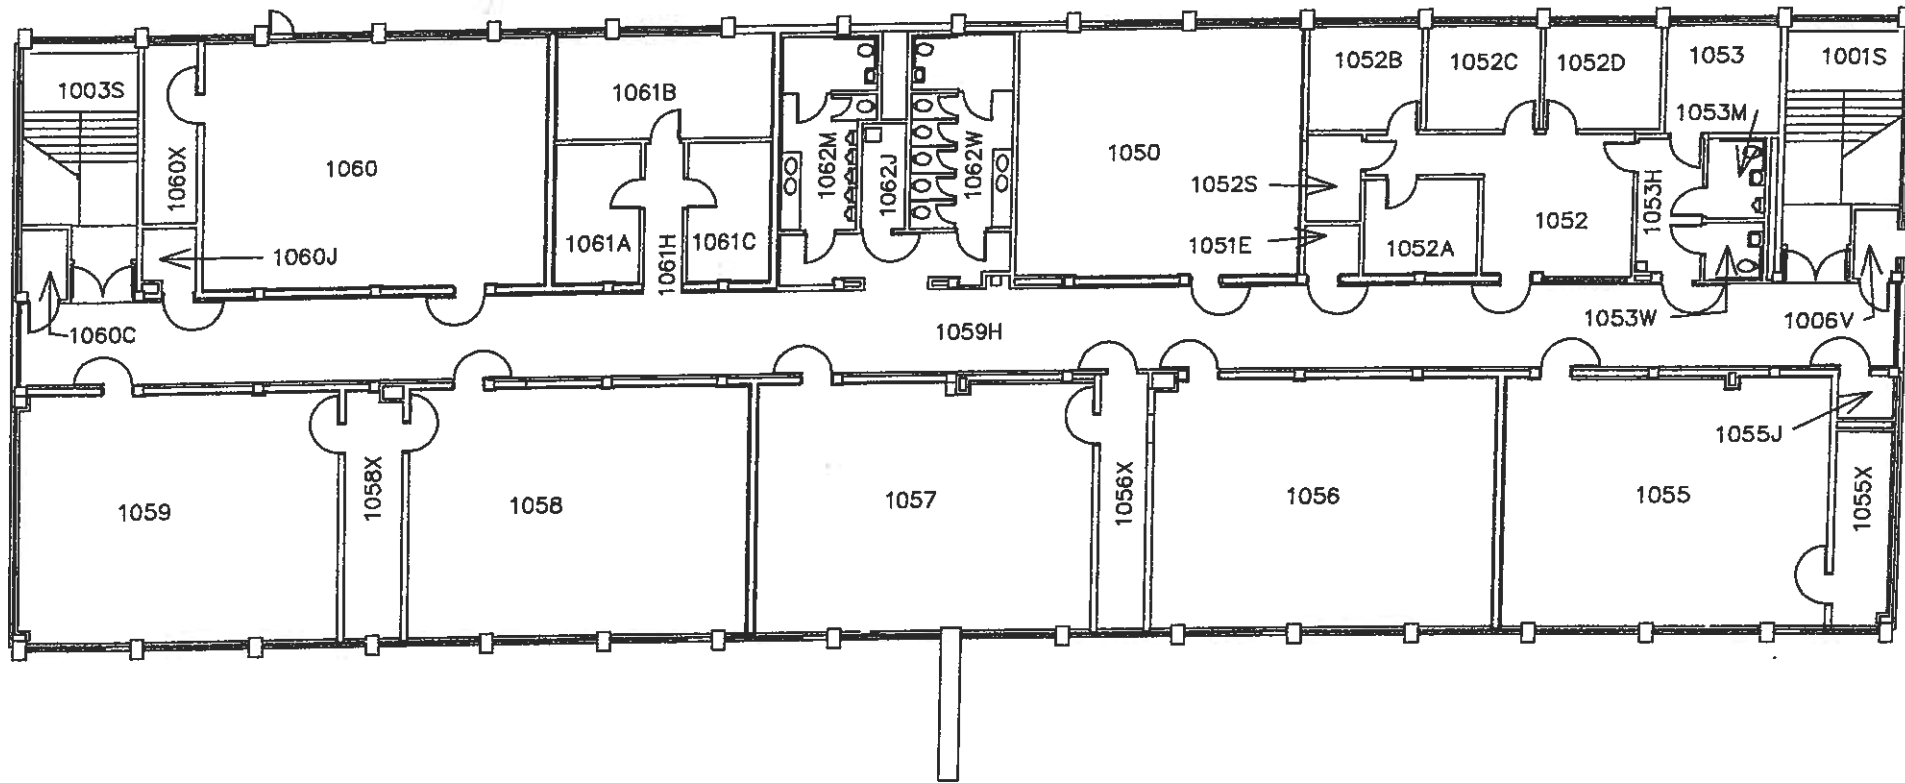


PENSACOLA JUNIOR COLLEGE  
 PENSACOLA CAMPUS  
 SITE NO. 1  
 FACILITY NO. 10  
 FACILITY NAME: BUSINESS EDUCATION  
 SECOND FLOOR




# CLASSROOM ASSIGNMENTS 2008 HOBBS CENTER

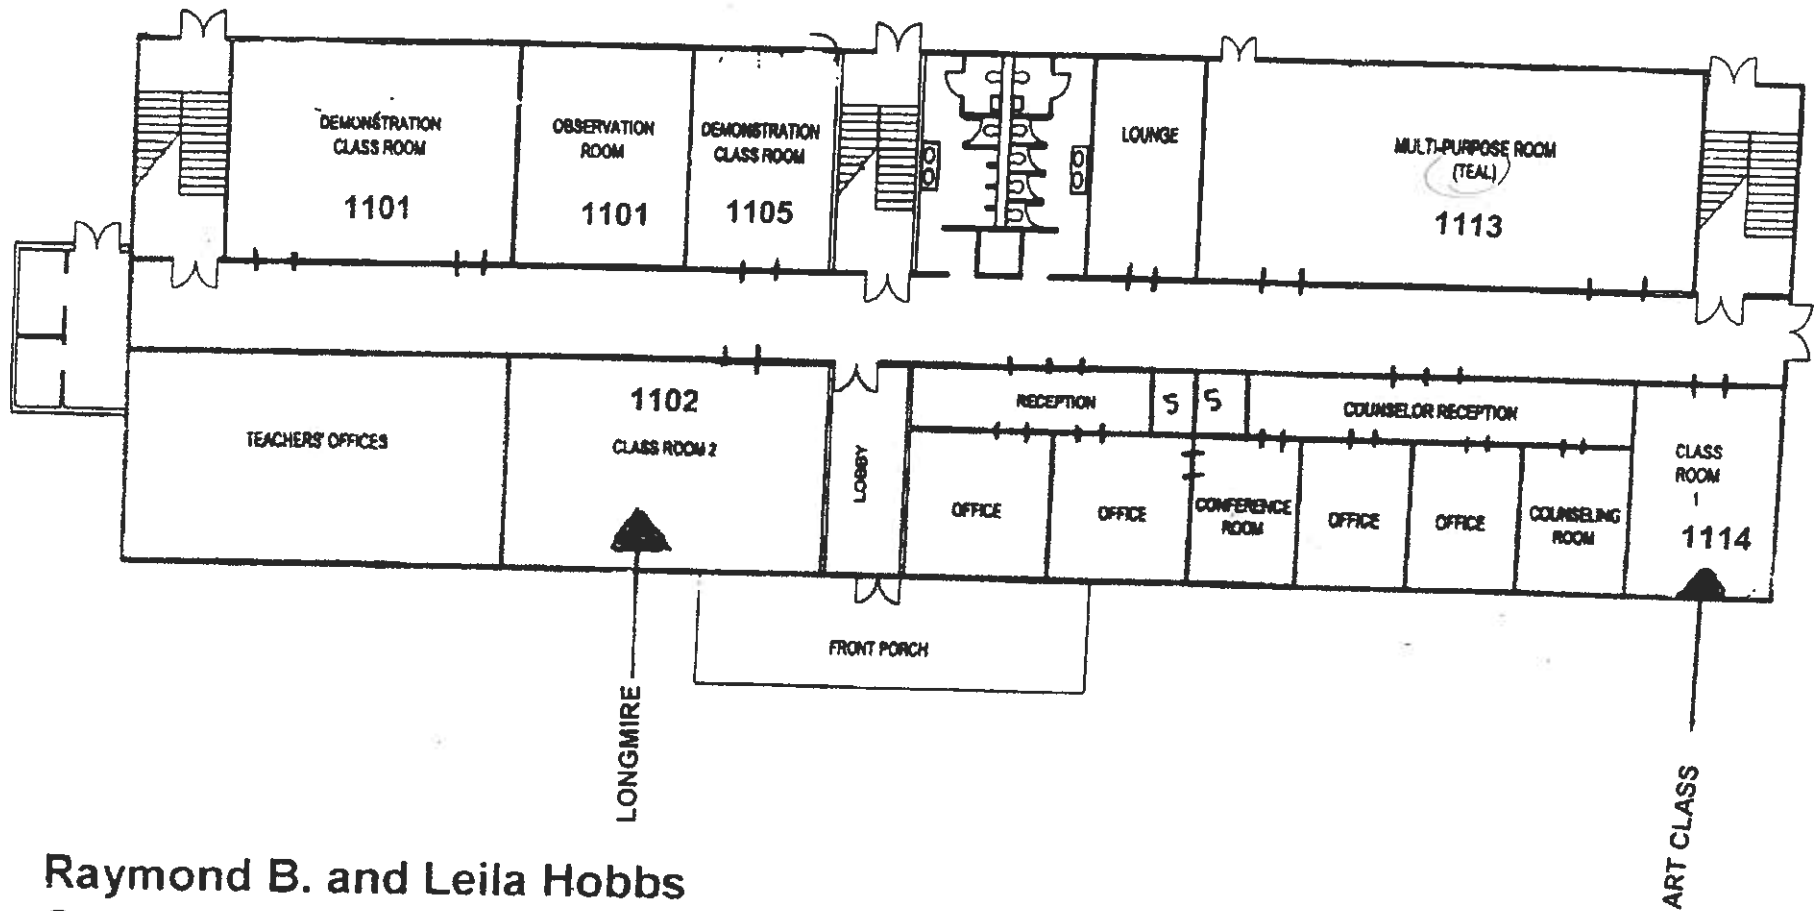

Raymond B. and Leila Hobbs  
Center for Teaching Excellence  
First Floor

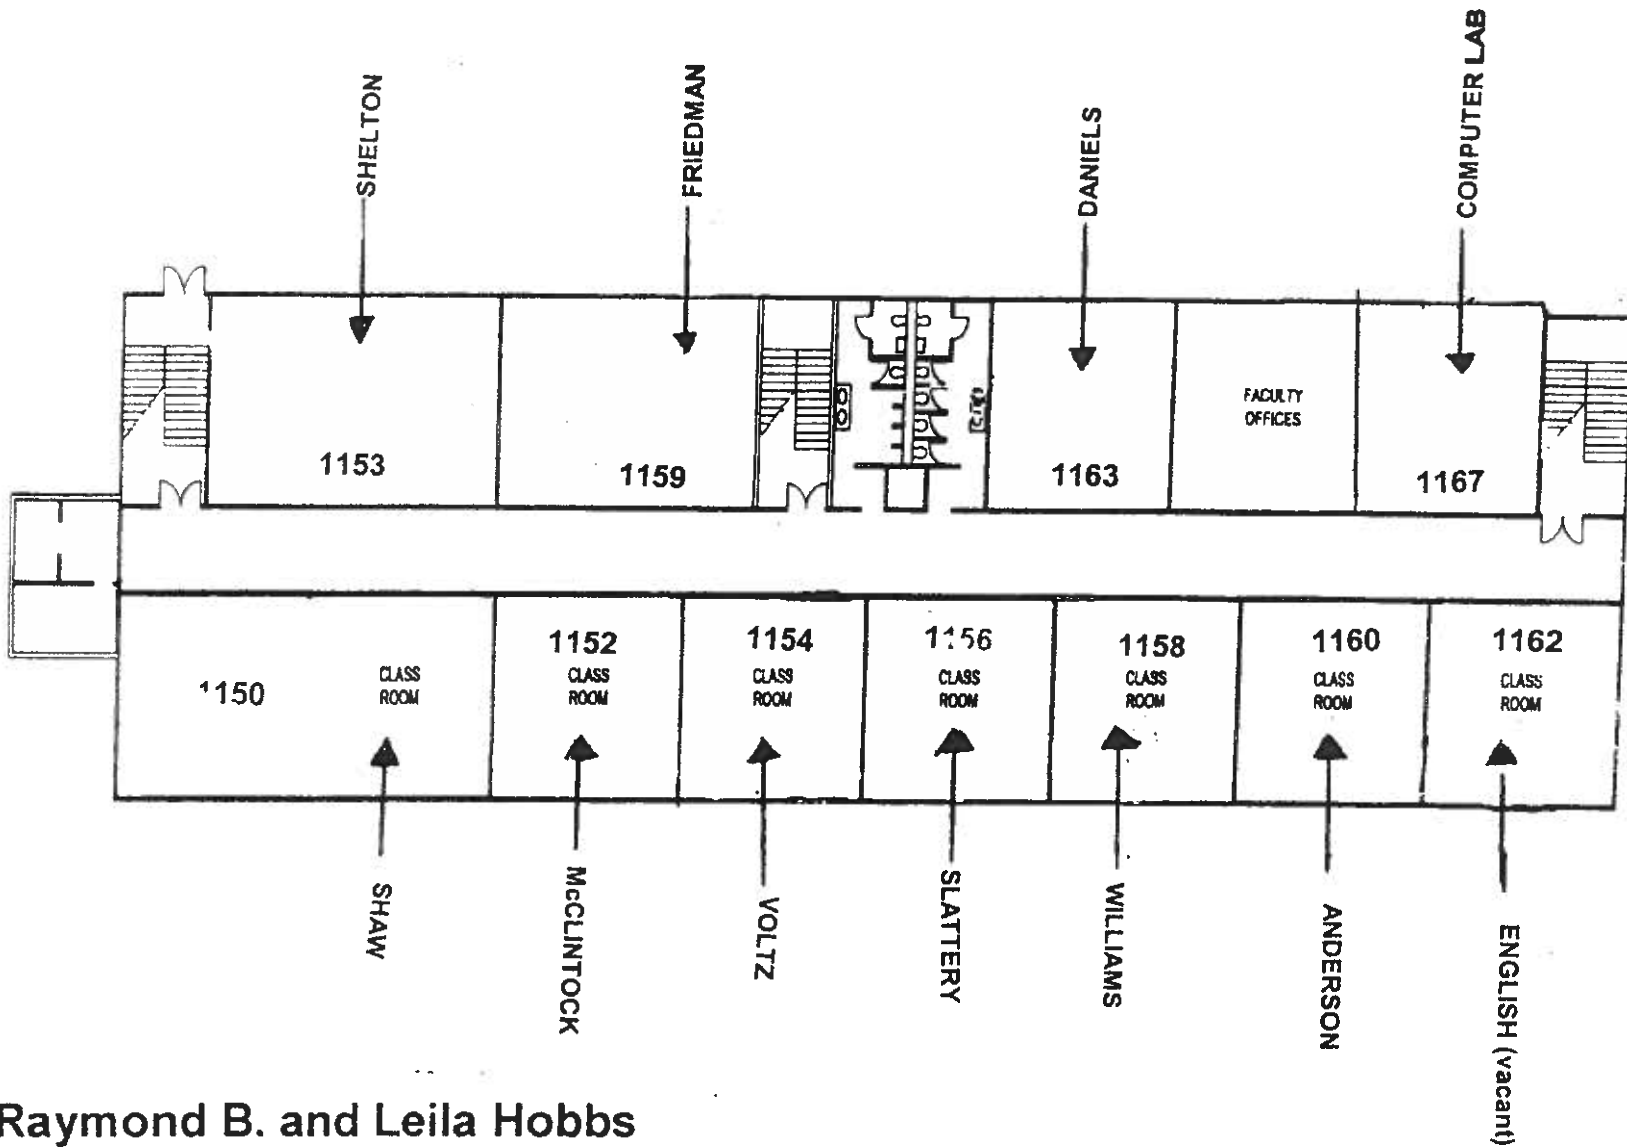


Raymond B. and Leila Hobbs  
 Center for Teaching Excellence  
 Second Floor

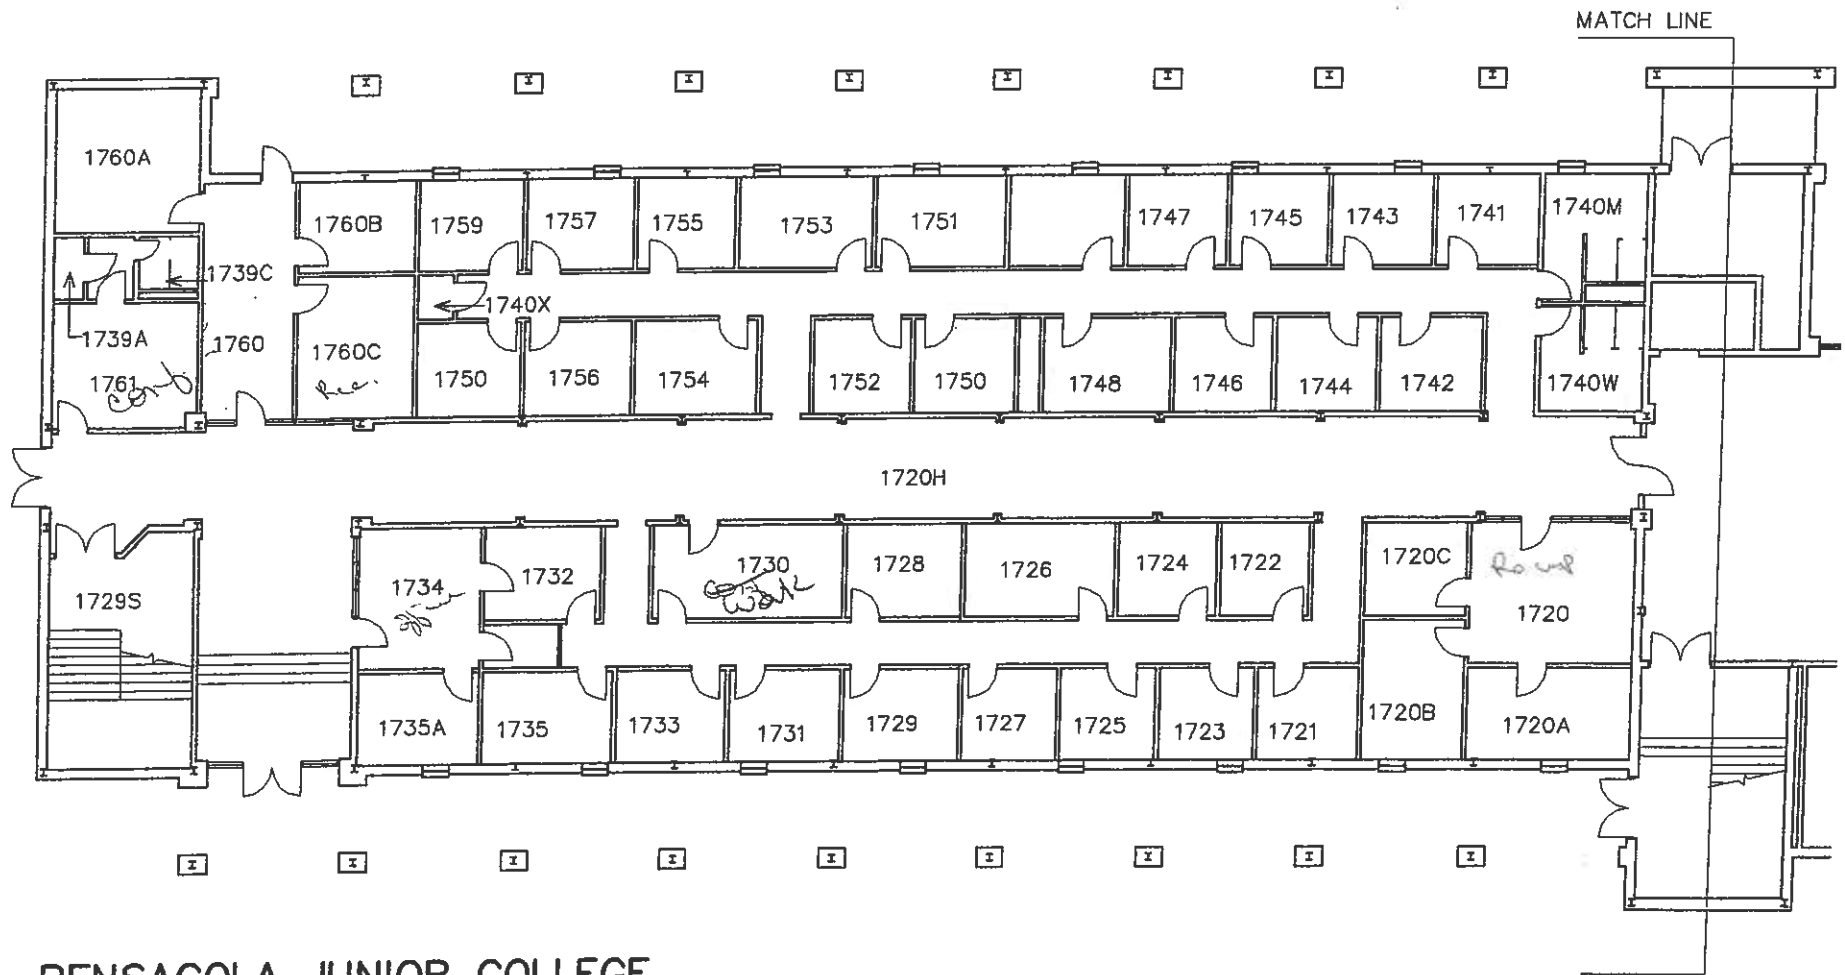

PENSACOLA JUNIOR COLLEGE  
 SITE NO. 1  
 FACILITY NO. 17  
 FACILITY NAME: SCIENCE & TECHNOLOGY EAST  
 FIRST FLOOR WEST






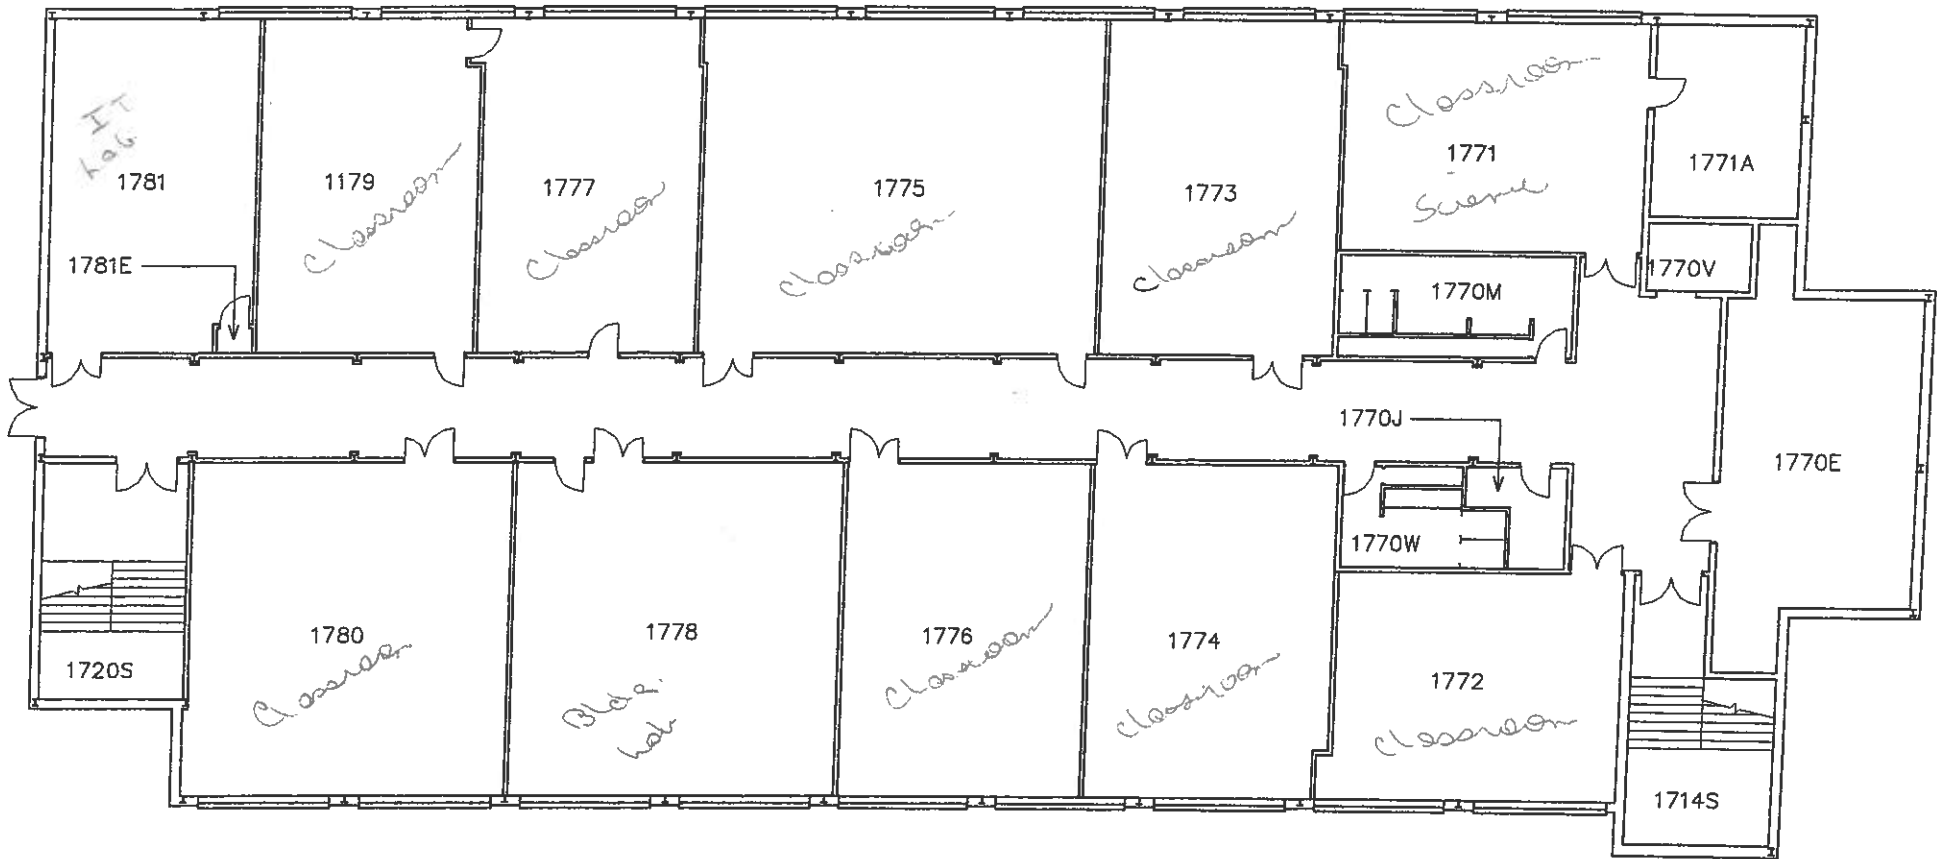


PENSACOLA JUNIOR COLLEGE  
 SITE NO. 1  
 FACILITY NO. 17  
 FACILITY NAME: SCIENCE & TECHNOLOGY EAST  
 SECOND FLOOR WEST



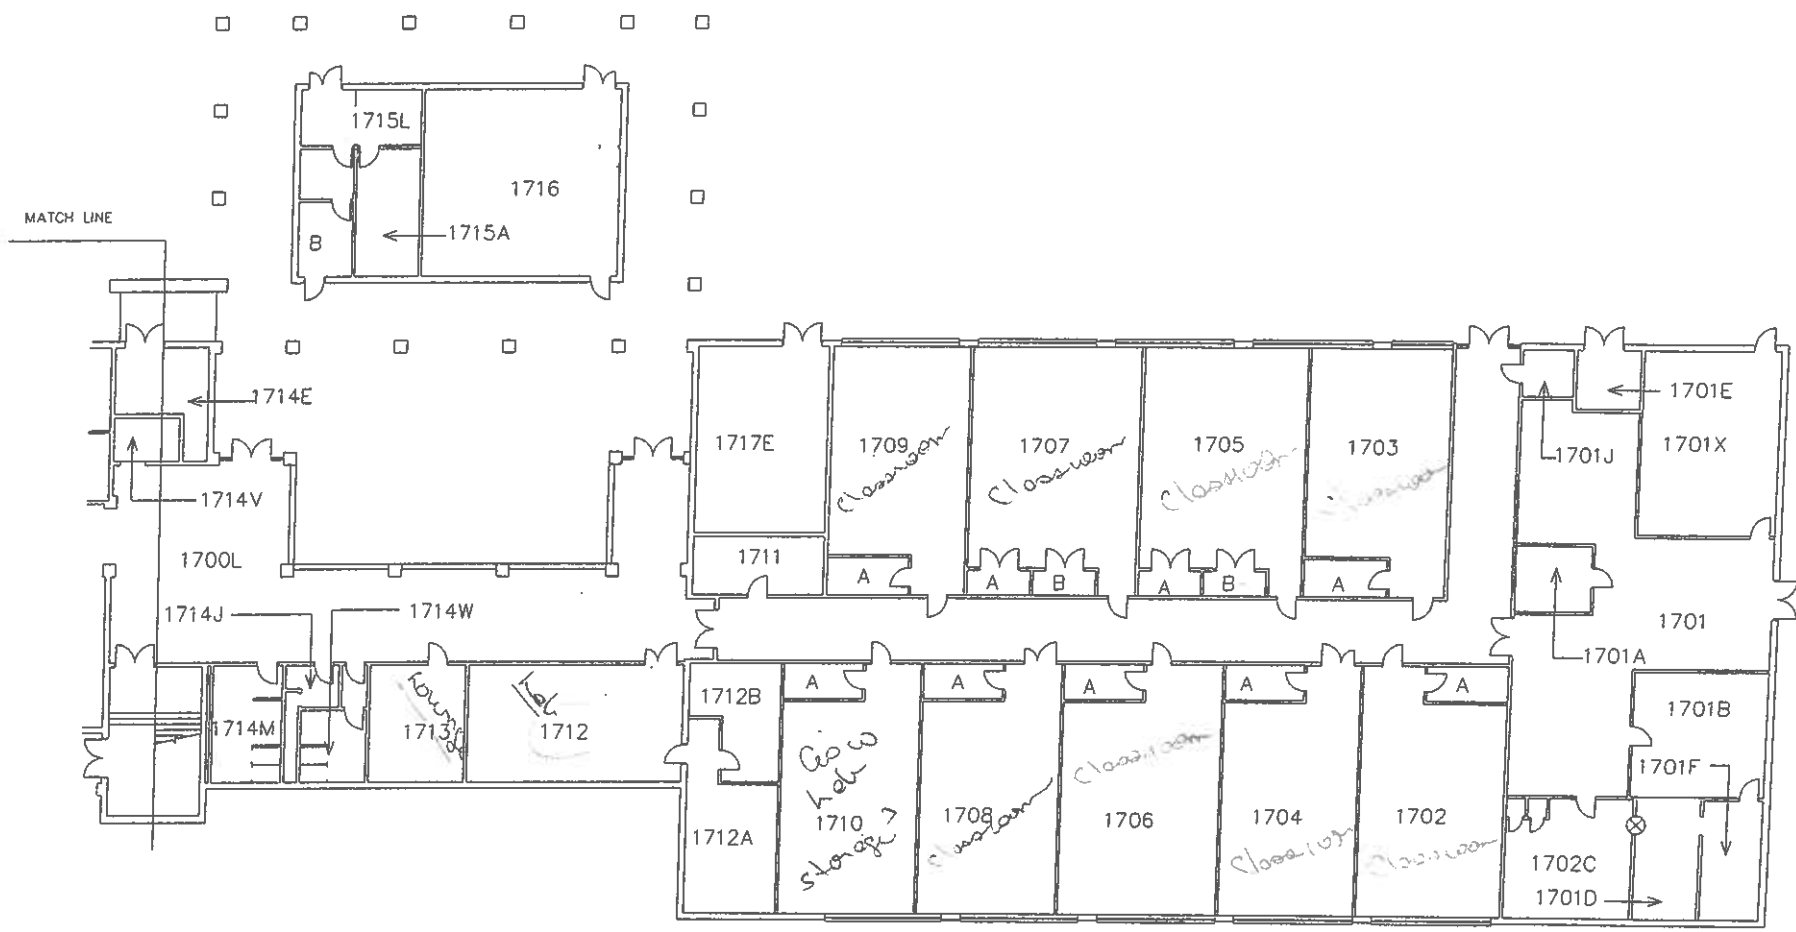


PENSACOLA JUNIOR COLLEGE  
SITE NO. 1  
FACILITY NO. 17  
FACILITY NAME: SCIENCE & TECHNOLOGY EAST  
FIRST FLOOR EAST



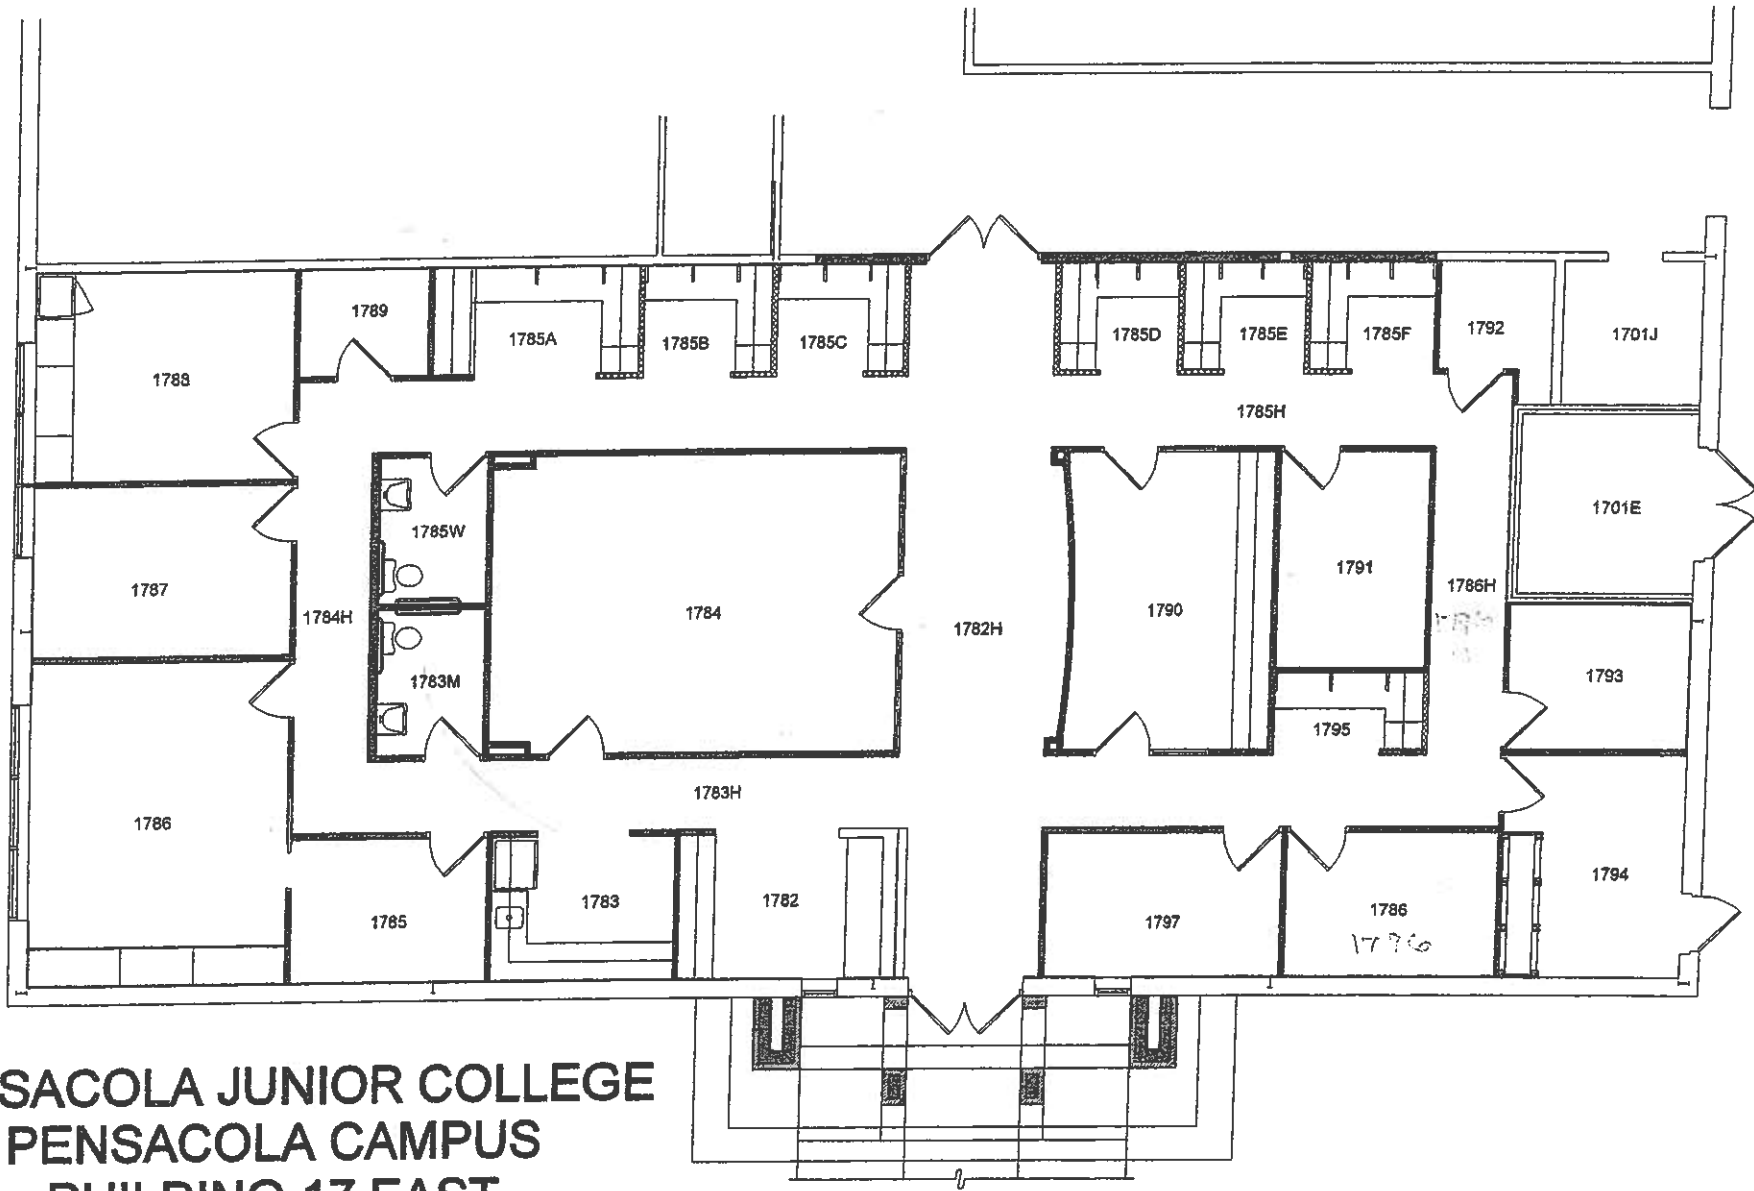


**PENSACOLA JUNIOR COLLEGE  
PENSACOLA CAMPUS  
BUILDING 17 EAST  
PJC FOUNDATION**

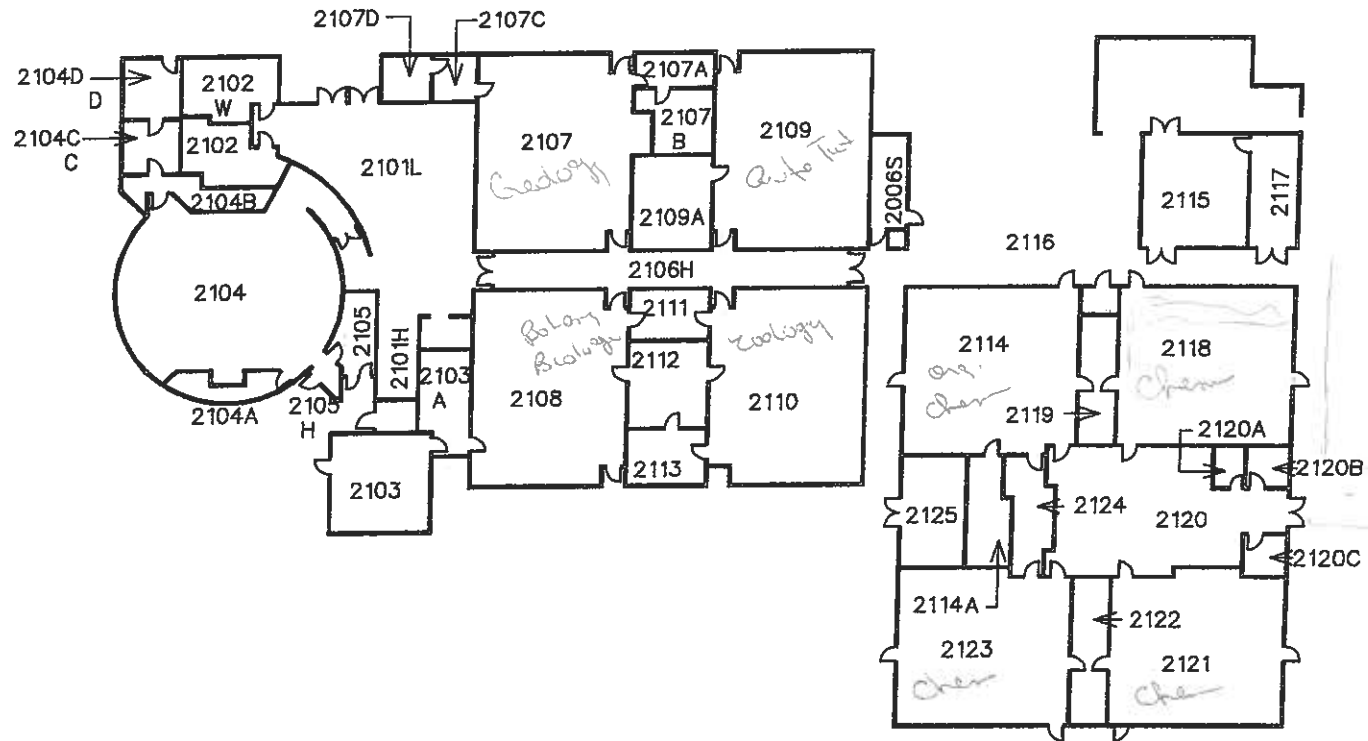

PENSACOLA JUNIOR COLLEGE  
 PENSACOLA CAMPUS  
 SITE NO. 1  
 FACILITY NO. 21  
 FACILITY NAME: SCIENCE & TECHNOLOGY WEST  
 FIRST FLOOR SOUTH






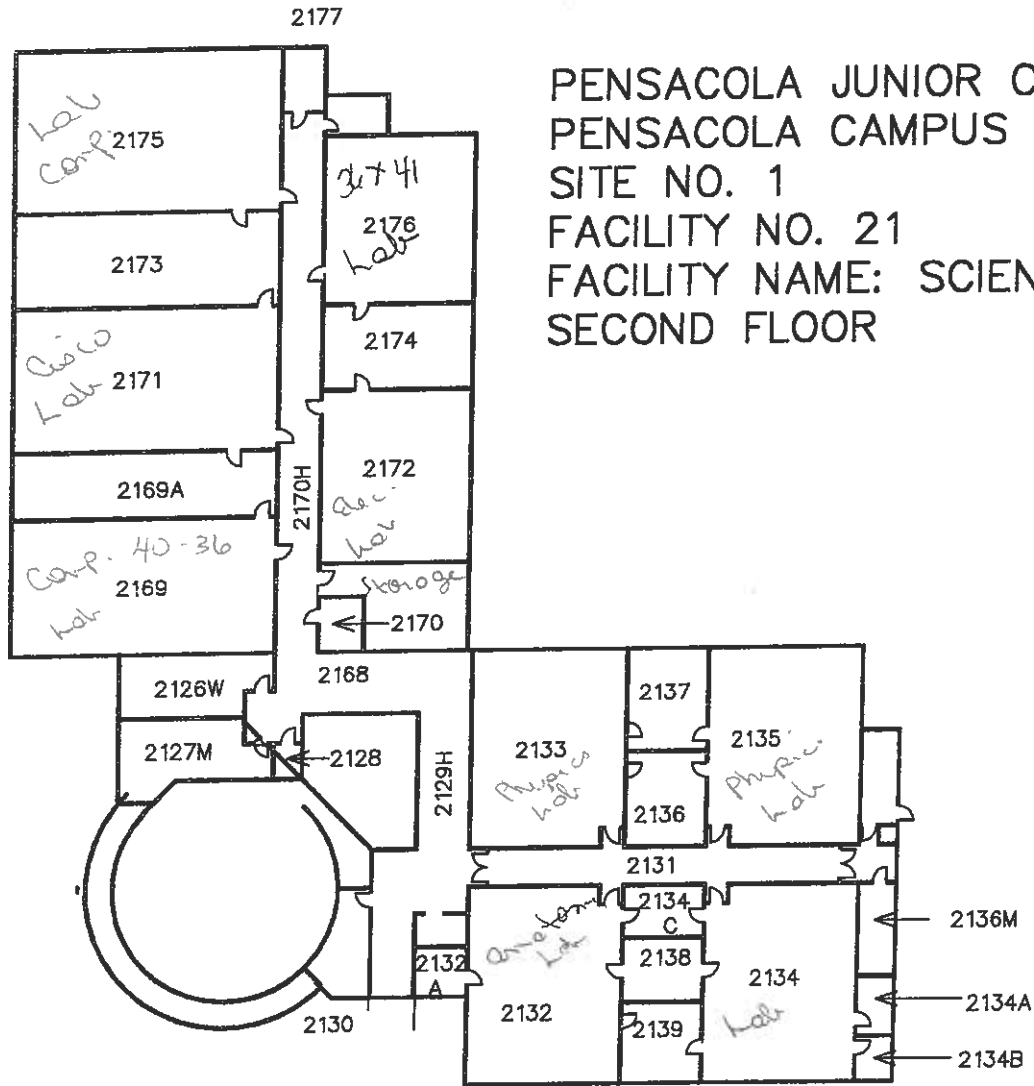

PENSACOLA JUNIOR COLLEGE  
 PENSACOLA CAMPUS  
 SITE NO. 1  
 FACILITY NO. 21  
 FACILITY NAME: SCIENCE & TECHNOLOGY WEST  
 SECOND FLOOR



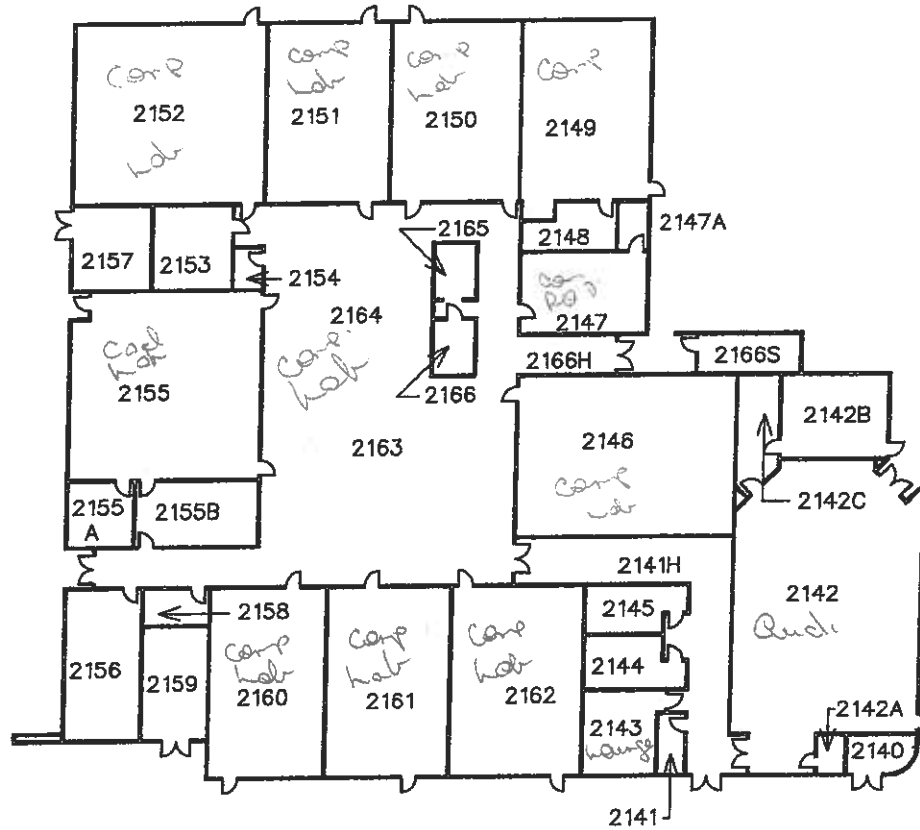

PENSACOLA JUNIOR COLLEGE  
PENSACOLA CAMPUS  
SITE NO. 1  
FACILITY NO. 21  
FACILITY NAME: SCIENCE & TECHNOLOGY WEST  
FIRST FLOOR NORTH

